

# NEW OFFICE

## CHRISTIAN COUNTY SHERIFF'S DEPARTMENT

### 214 WEST MARKET STREET

### TAYLORVILLE, ILLINOIS 62568



ARCHITECT / ENGINEER:

**HURST-ROSCHE, INC.**  
 200 N. MARKET ST.  
 MARION, ILLINOIS 62959  
 (618) 998-0075

1400 E. TREMONT ST., P.O. BOX 130  
 HILLSBORO, ILLINOIS 62049  
 (217) 532-3959


NO. 5 BANK SQUARE  
 EAST ST. LOUIS, ILLINOIS 62203  
 (618) 398-0890

3675 W. OUTER RD., SUITE 205  
 ARNOLD, MISSOURI 63010  
 (636) 333-3351

1101 KERMIT DRIVE, SUITE 620  
 NASHVILLE, TENNESSEE 37217  
 (615) 454-6615

2121 W. WHITE OAKS DR., SUITE D  
 SPRINGFIELD, ILLINOIS 62704  
 (217) 679-1671

PROJECT LOCATION

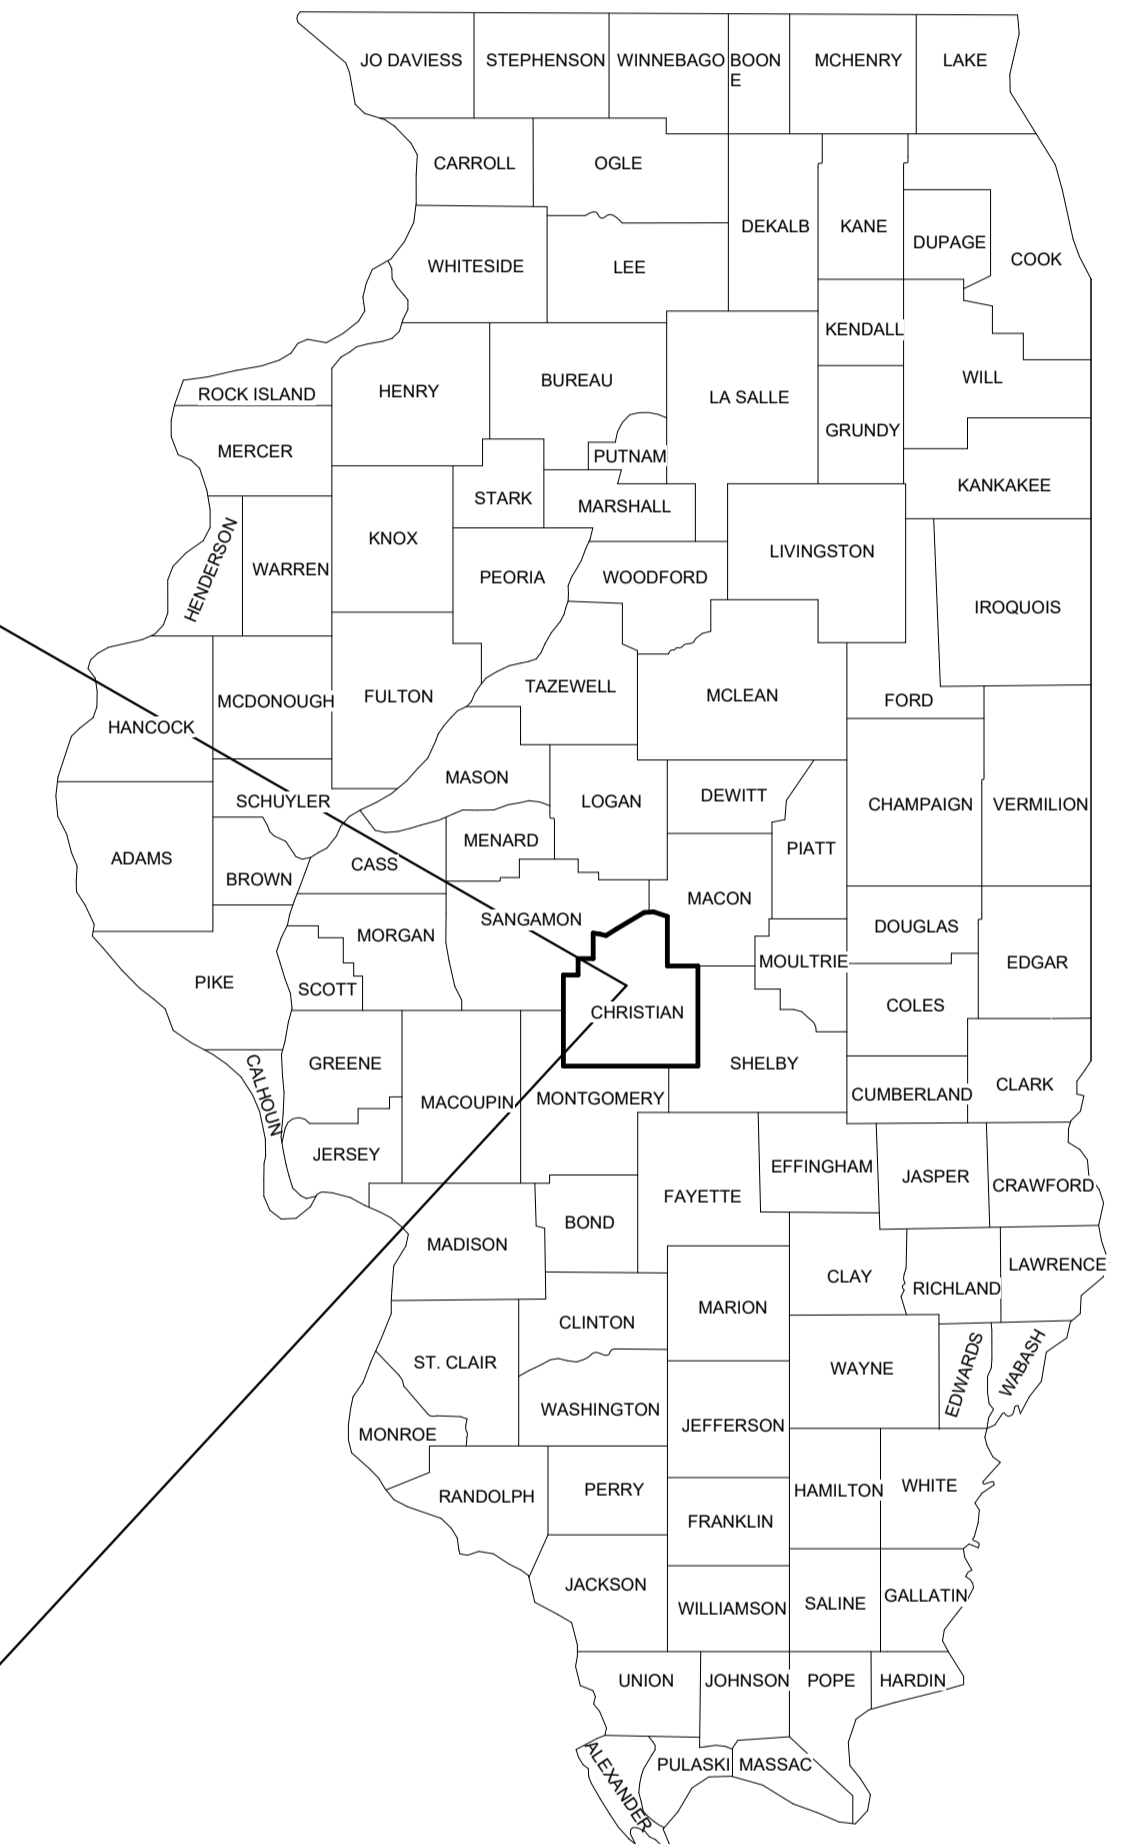

AREA LOCATION MAP



*Karl Tabor*  
 KARL TABOR, AIA  
 DATE: 03.15.2024  
 LICENSE EXPIRES: 11-30-2024

DATE: 03.15.2024

SYMBOL LEGEND			
CONCRETE	GYPSUM	WOOD	STEEL
RIGID INS	BRICK	CMU	BATT INS

SHEET LIST	
SHEET NUMBER	SHEET NAME
G-101	COVER SHEET
G-102	GENERAL NOTES
G-103	HEALTH/LIFE SAFETY PLAN
D-101	DEMOLITION PLANS
A-101	NEW FLOOR PLANS
A-110	REFLECTED CEILING PLANS
A-601	SCHEDULES, ELEVATIONS, AND DETAILS
MD-101	MECHANICAL DEMOLITION PLANS
M-101	MECHANICAL PLANS
M-601	MECHANICAL SCHEDULES AND DETAILS
ED-101	ELECTRICAL DEMOLITION PLANS
E-101	ELECTRICAL PLANS

- GENERAL NOTES**
- PERMITS AND LICENSES FOR THE WORK SHALL BE SECURED AND PAID BY THE CONTRACTOR.
  - CONTRACTOR SHALL COORDINATE WITH OWNER FOR ALL ACTIVITY, PROCEDURES, CLEARANCES, AND REQUIREMENTS TO ACCESS THE EXISTING FACILITIES. SUCH PROCEDURES ARE INCIDENTAL TO THE CONTRACT AND SHALL NOT RESULT IN EXTRA COSTS TO OWNER.
  - CONTRACTORS SHALL COORDINATE ALL WORK, INCLUDING CONTRACTOR PARKING AND CONSTRUCTION STAGING, WITH THE OWNER, ARCHITECT/ENGINEER, AND OTHER CONTRACTORS THROUGHOUT THE PROJECT.
  - THE CONTRACTOR SHALL TAKE NOTE OF ALL EXISTING SITE CONDITIONS AND BE PREPARED TO MOVE OR DISPOSE OF OBJECTS OR MATERIALS WITHIN THE LIMITS OF THE PROJECT. SUCH WORK SHALL NOT BE CAUSE FOR ADDITIONAL COMPENSATION FOR CHANGE IN SCOPE.
  - CONTRACTOR SHALL FIELD VERIFY ALL EXISTING DIMENSIONS AND CONDITIONS AND MAKE MINOR ADJUSTMENTS AS NECESSARY. NOTIFY THE ARCHITECT/ENGINEER OF ANY DISCREPANCIES WHICH MAY AFFECT THE OUTCOME OF THE WORK. DIMENSIONS SHOWN ARE FROM FACE OF FINISH UNLESS NOTED AS FACE OF STUD OR OTHERWISE.
  - DIMENSIONS NOTED ON THE DRAWINGS ARE FOR GENERAL INFORMATION ONLY. PRIOR TO SUBMITTING A BID PROPOSAL, THE CONTRACTOR SHALL THOROUGHLY SURVEY THE EXISTING FACILITIES TO VERIFY EXISTING INTERIOR DIMENSIONS, CONDITIONS, AND DETERMINE ALL MATERIALS, LABOR AND INCIDENTALS NEEDS FOR COMPLETION OF THE INTENDED DESIGN/CONSTRUCTION. THE CONTRACTOR SHALL VERIFY ALL EXISTING DIMENSIONS AND FIELD CONDITIONS PRIOR TO FABRICATION OR CONSTRUCTION; MAKE MINOR ADJUSTMENTS; AND NOTIFY THE ARCHITECT/ENGINEER OF ANY CONDITIONS THAT MAY AFFECT THE OUTCOME OF THE WORK.
  - NEW WORK SHALL MATCH EXISTING ADJOINING CONSTRUCTION FOR A SMOOTH TRANSITION, EXCEPT WHERE NOTED.
  - PROTECT EXISTING UTILITIES DURING CONSTRUCTION.
  - CONTRACTOR SHALL NOTIFY OWNER AND ARCHITECT/ENGINEER PRIOR TO USE OF ANY SCAFFOLDING, LIFTS, SWING STAGES, ETC. USE OF SUCH MATERIALS AND EQUIPMENT SHALL MEET ALL FEDERAL, STATE, AND LOCAL SAFETY REGULATIONS AND ORDINANCES.
  - PROVIDE AND INSTALL BITUMINOUS PAINT WHERE INSTALLATION OF DISSIMILAR METALS OCCUR.
  - ALL GYP BD IN BASEMENT AND OTHER AREAS WHERE MOISTURE WILL LIKELY OCCUR SHALL BE MOISTURE RESISTANT TYPE 'X' GYP BD.
  - ALL EXISTING FINISHES DISTURBED DURING CONSTRUCTION SHALL BE RESTORED TO A CONDITION AT LEAST EQUAL WITH CONDITIONS BEFORE CONSTRUCTION BEGAN. AFTER ALL WORK IS COMPLETED, CONTRACTOR SHALL CLEAN WORK AREAS SO THAT THEY ARE FREE OF ANY CONSTRUCTION MATERIALS, TOOLS, DIRT AND DEBRIS.
  - ALL ITEMS NOTED TO REMAIN SHALL NOT BE DISTURBED AND SHALL REMAIN IN PLACE. CONTRACTOR SHALL MAKE EVERY EFFORT TO MINIMIZE ANY DISTURBANCES. IN THE EVENT EXISTING ITEMS ARE DISTURBED, CONTRACTOR SHALL REPAIR/REPLACE WITH EQUAL OR BETTER CONSTRUCTION AT THE CONTRACTOR'S EXPENSE.
  - GENERAL CONTRACTOR SHALL COORDINATE REMOVAL, HAULING, AND LEGAL DISPOSAL OF ALL MATERIALS WITH SUBCONTRACTORS.
  - CONTRACTOR SHALL MAINTAIN PROJECT SITE FREE FROM CONSTRUCTION DEBRIS AS REQUIRED BY THE OWNER. COORDINATE WITH OWNER.
  - ALL REFUSE AND DEBRIS SHALL BE REMOVED FROM THE SITE AND LEGALLY DISPOSED OF BY THE CONTRACTOR. GENERAL CONTRACTOR SHALL COORDINATE REMOVAL, HAULING, AND LEGAL DISPOSAL OF ALL MATERIALS WITH SUBCONTRACTORS. CLEAN ALL WORK AREAS DAILY.
  - AFTER ALL WORK IS COMPLETED, CONTRACTOR SHALL CLEAN ALL AREAS AFFECTED BY CONSTRUCTION SO THAT THEY ARE FREE OF ANY CONSTRUCTION DIRT AND DEBRIS.

APPLICABLE CODES
2009 IBC - INTERNATIONAL BUILDING CODE
2009 IMC - INTERNATIONAL MECHANICAL CODE
2011 NEC - NATIONAL ELECTRICAL CODE

ABBREVIATIONS			
ABV	ACCESS	HP	HORSEPOWER
A.C.T.	ACOUSTICAL CEILING TILE	HORIZ	HORIZONTAL
ACU	AIR CONDITIONING UNIT	HSS	STRUCTURAL TUBE
ADJ	ADJACENT	HT	HEIGHT
ADJT	ADJUSTABLE	HTG	HEATING
AFF	ABOVE FINISHED FLOOR	HVAC	HEATING, VENTILATION, AND
AHU	AIR HANDLING UNIT	AIR COND	AIR CONDITIONING
ALT	ALTERNATE, ALTERNATIVE	HWS	HOT WATER SUPPLY
ALUM	ALUMINUM	IN	INCH
AMPS	AMPERES	INS	INSULATE, (D), (ION)
AUTO	AUTOMATIC	INT	INTERIOR
BD	BOARD	JT	JOINT
BLDG	BUILDING	KPL	KICKPLATE
B.O.	BOTTOM OF	L	LENGTH
BTU/H	BRITISH THERMAL UNIT PER	LL	LIVE LOAD
HOUR		LLC	LOCAL LIGHTING CONTROLLER
BTWN	BETWEEN	LT	LIGHT
CASS	CASSETTE	M/MECH	MECHANICAL
CF	CUBIC FOOT	MAX	MAXIMUM
CFL	COUNTERFLASHING	MBH	1,000 BTH/H
CJ	CONTROL JOINT	MED	MEDIUM
CLG	CEILING	MFG	MANUFACTURE, (ER), (ING)
CMU	CONCRETE MASONRY	MIN	MINIMUM
CO	CLEAN OUT	MISC	MISCELLANEOUS
COL	COLUMN	MO	MASONRY OPENING
CONC	CONCRETE	MOV	MOVABLE
CONST	CONSTRUCTION	MP	METAL PANEL
CONT	CONTINUOUS	MT	MOUNT, (ED), (ING)
CONTR	CONTRACTOR,	MTL	METAL
CONTROLLER	BOX	NO	NUMBER
COTF	CLEAN OUT TO FLOOR	NOM	NOMINAL
COTG	CLEAN OUT TO GRADE	OA	OUTDOOR AIR
COTW	CLEAN OUT TO WALL	OC	ON CENTER
CPT	CARPET	OH	OVERHEAD
CS	COUNTERSINK	OS	OCCUPANCY SENSOR
CSBA	COLD WATER SUPPLY	OPP	OPPOSITE
		OWSJ	OPEN WEB STEEL JOIST
DBL	DOUBLE	PEMB	PRE-ENGINEERED MTL BLDG
DEG	DEGREES	PP	POWER PACK
DEMO	DEMOLISH, DEMOLITION	PS	PULL SWITCH
DIAG	DIAGONAL	PT	PAINT (ED)
DIA	DIAMETER	RB	RUBBER BASE
DIM	DIMENSION	RF	RUBBER FLOORING
DISP	DISPENSER	RM	ROOM
DIV	DIVISION	RO	ROUGH OPENING
DR	DOOR	RR	RESTROOM
DS	DOWNSPOUT	RTU	ROOF TOP UNIT
DT	DRAINTILE	SHT	SHEET
DWG	DRAWING	SIM	SIMILAR
EL	EMERGENCY LIGHT	SS	STAINLESS STEEL
ELEC	ELECTRIC, ELECTRICAL	STL	STEEL
ERV	ENERGY RECOVERY	TB	TILE BASE
VENTILATOR		TO	TOP OF
EXG	EXISTING	TYP	TYPICAL
F	DEGREES FARENHEIT	UH	UNIT HEATER
FA	FIRE ALARM	VA	VOLT AMPS
FACP	FIRE ALARM CONTROL	VB	VAPOR BARRIER
PANEL		VTR	VENT THROUGH ROOF
FC	FAN COIL	WD	WOOD
FD	FLOOR DRAIN	WF	WALL FINISH
FF	FINISHED FLOOR	WH	WATER HEATER
FOUND	FOUNDATION	WP	WATER PROOFING
FP	FIREPROOF	W/	WITH
FT	FEET	W/O	WITHOUT
FTG	FOOTING		
GA	GAUGE		
GFCI	GROUNDFault CIRCUIT		
GWB	GYPSUM WALL BOARD		
GYP	GYPSUM		
HC	HOLLOW CORE		
HM	HOLLOW METAL		

**HURST-ROSCHKE, INC.**  
PROFESSIONAL DESIGN NUMBER: 194-000298  
 200 N. MARKET STREET  
 MARION, IL  
 PH: 618.998.0075

www.hurst-rosche.com  
 HILLSBORO, IL  
 EAST ST. LOUIS, IL  
 ARNOLD, MO  
 NASHVILLE, TN  
 SPRINGFIELD, IL

**KARL G. TABOR**  
 001-015084  
 LICENSED ARCHITECT


SIGNATURE: *Karl Tabor*  
 DATE: 03.15.2024  
 LICENSE EXPIRES: 11-30-2024

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**214 WEST MARKET STREET**  
**TAYLORVILLE, ILLINOIS 62568**  
**ISSUED FOR BID**

MARK	DATE	DESCRIPTION

DATE: 03.15.2024  
 PROJECT NO: HR: 390-1533  
 DESIGN: KGT    DRAWN: CIM    CHECK: KGT

GENERAL NOTES

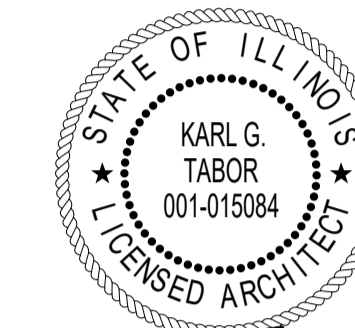


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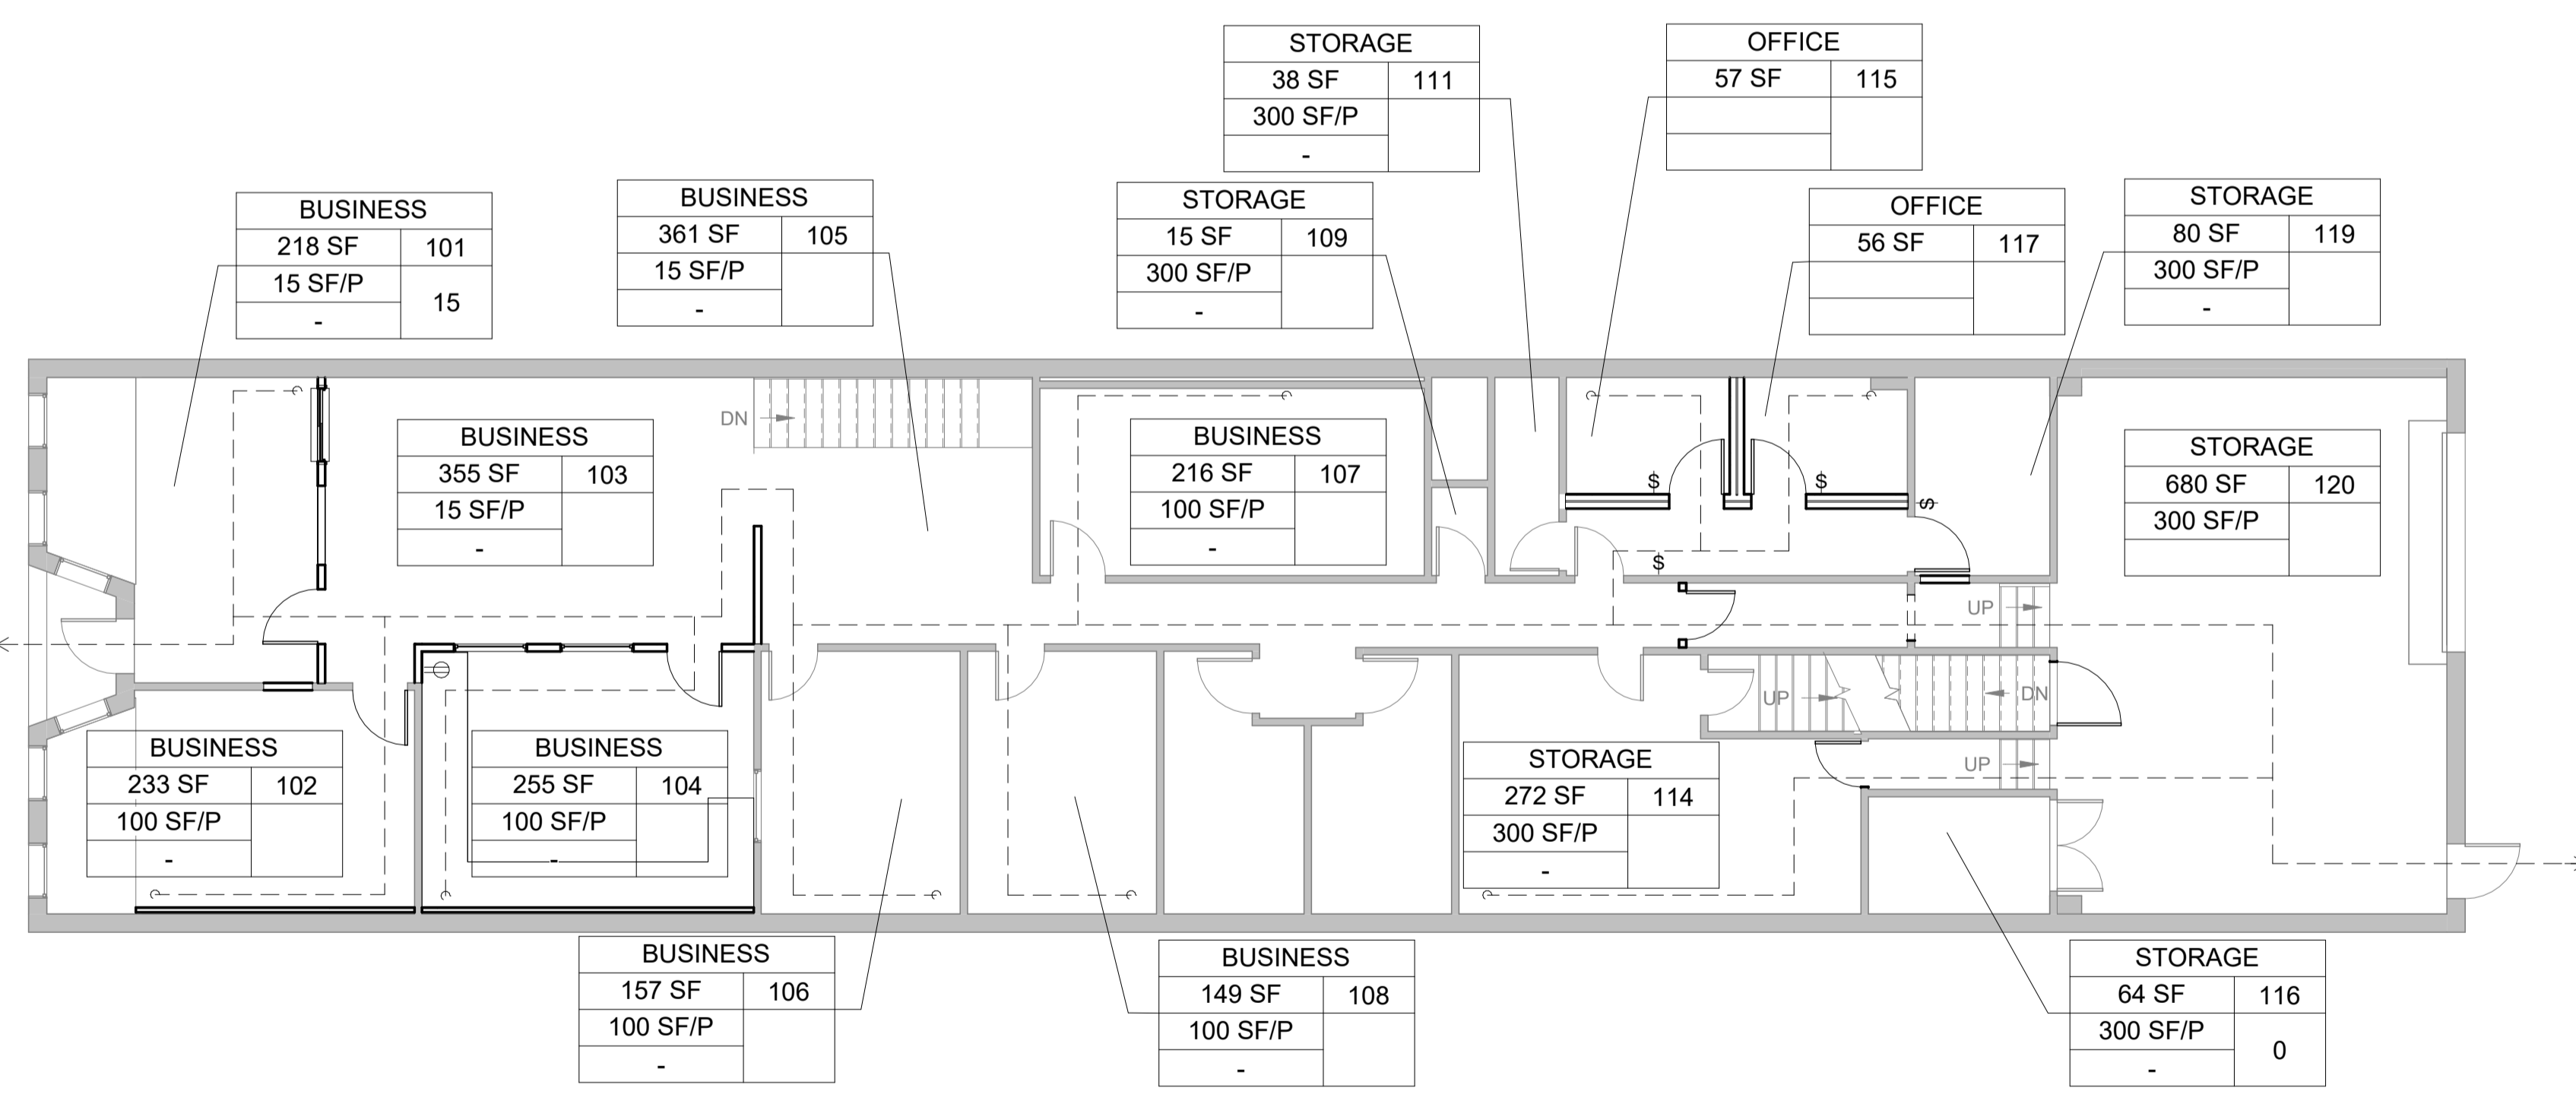
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**HEALTH/LIFE SAFETY PLAN**




**2**  
**G-103**  
**BASEMENT HEALTH/LIFE SAFETY PLAN**  
 SCALE: 1/8" = 1'-0"



**1**  
**G-103**  
**FIRST FLOOR HEALTH/LIFE SAFETY PLAN**  
 SCALE: 1/8" = 1'-0"

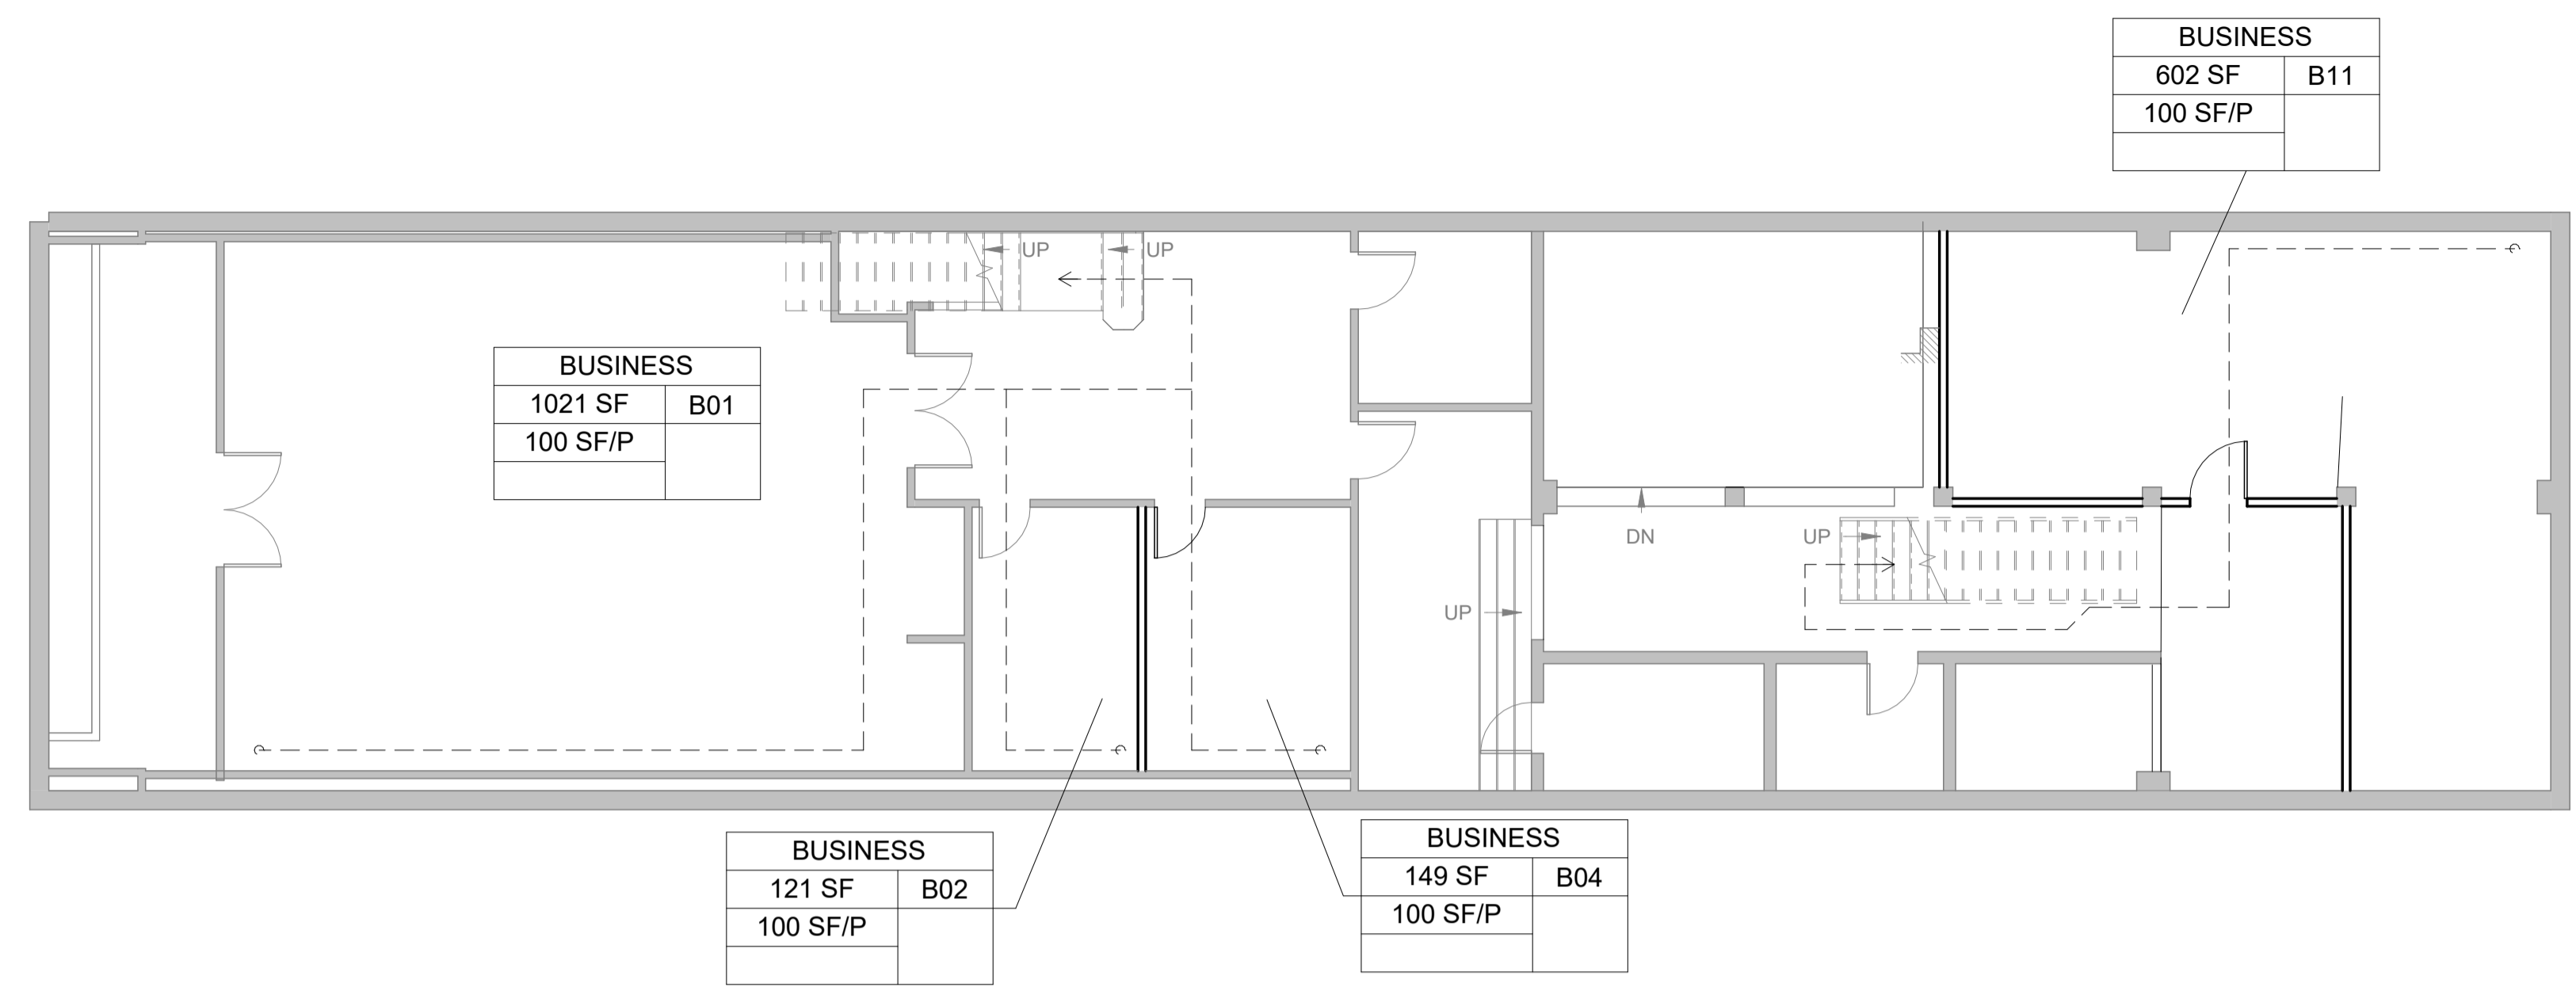**KEY LEGEND**


ROOM AREA (SQ FT)	BUSINESS	OCCUPANCY
OCC. LOAD RATE	100 SF   101	ROOM NUMBER
	15 SF/P   6	DESIGN OCC. LOAD

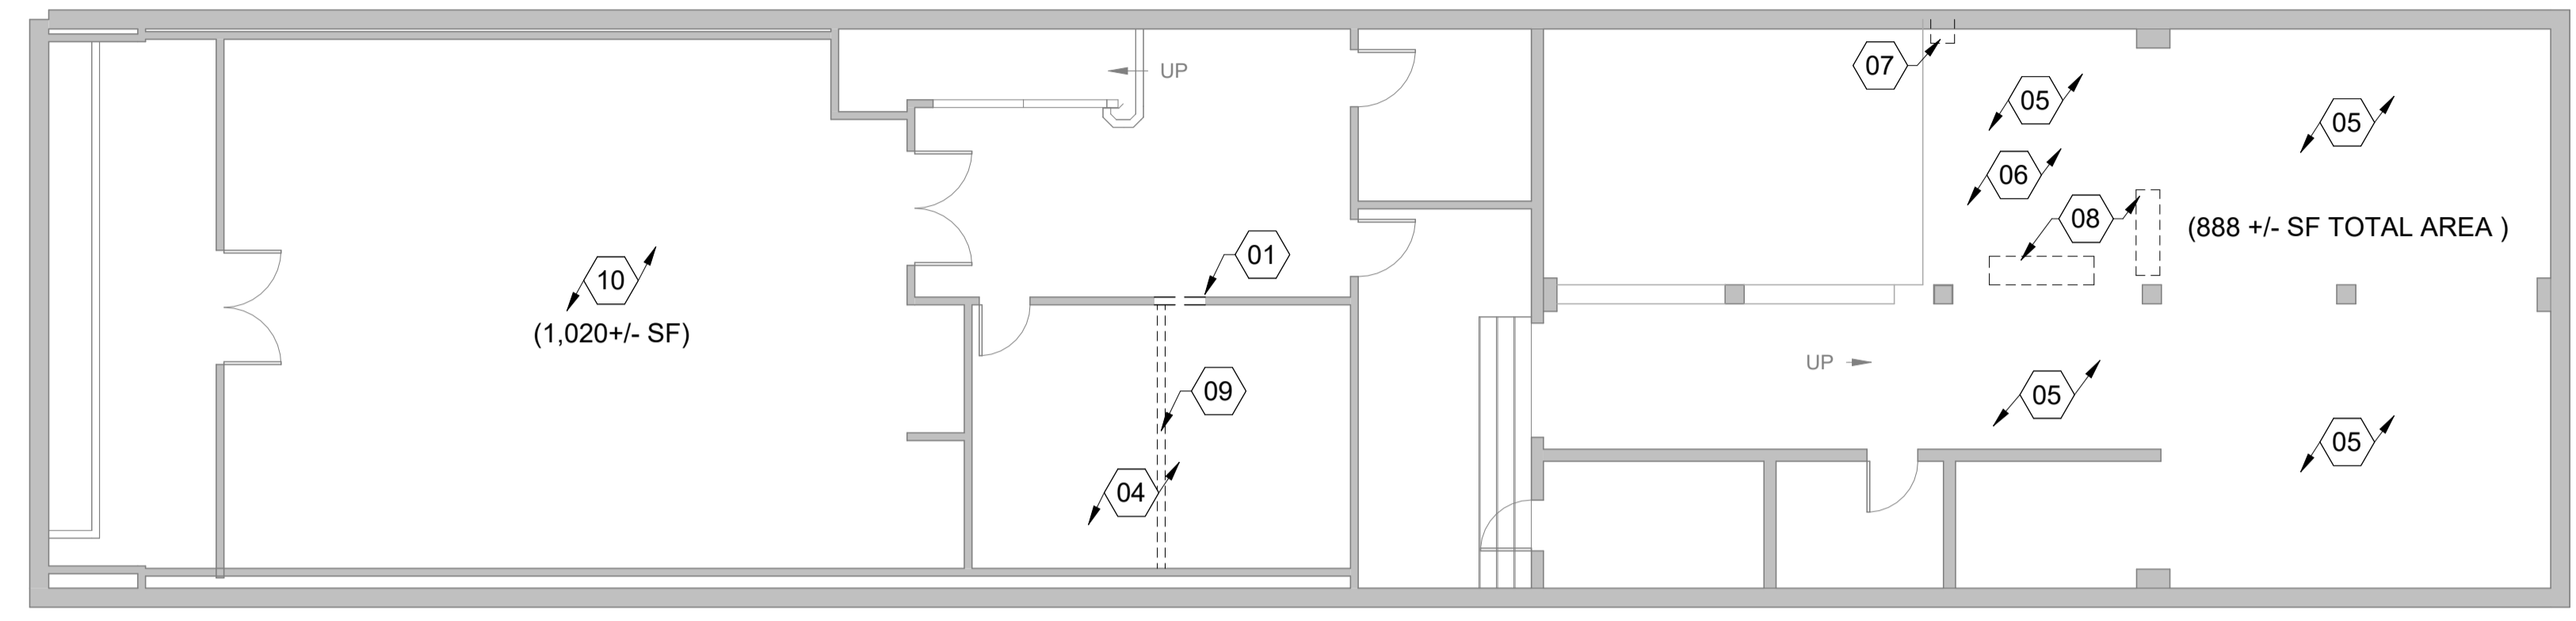

**1**  
D-101  
**BASEMENT DEMOLITION PLAN**

0' 4' 8' 16' 32'

SCALE: 1/8" = 1'-0"

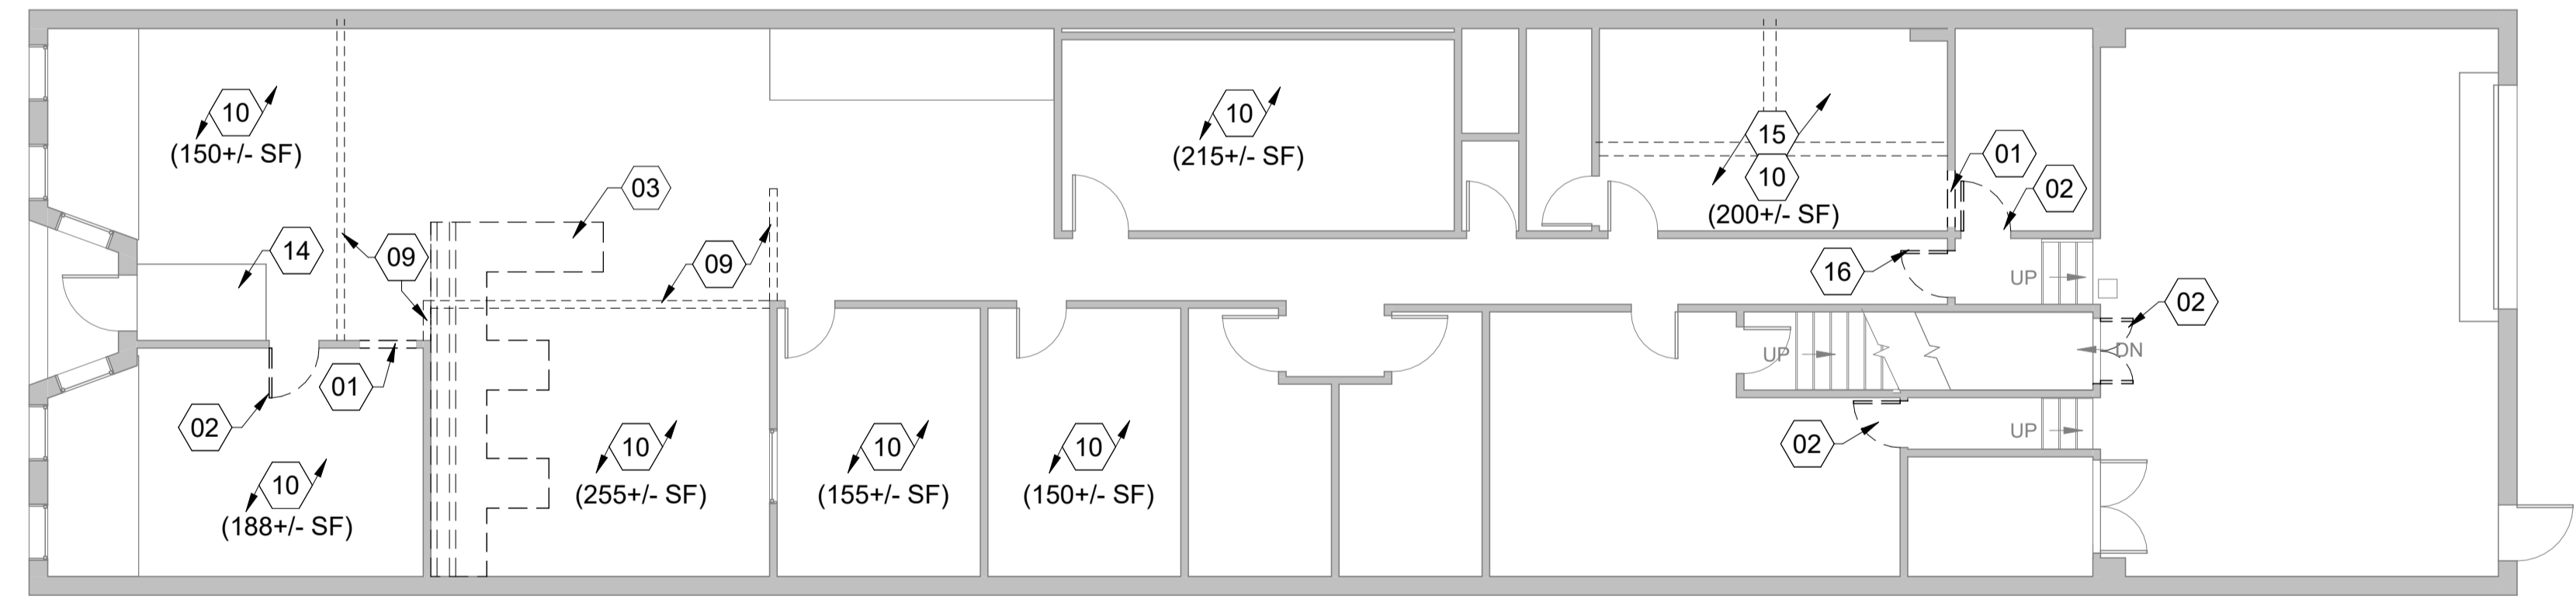

**2**  
D-101  
**FIRST FLOOR DEMOLITION PLAN**

0' 4' 8' 16' 32'

SCALE: 1/8" = 1'-0"

KEYNOTE LEGEND	
MARK	KEYNOTE
01	DEMO PORTION OF EXISTING WALL, PREP FOR NEW DOOR INSTALLATION.
02	DEMO EXISTING DOOR AND FRAME.
03	REMOVE EXISTING CASEWORK.
04	MODIFICATIONS TO EXISTING CEILING TILES, MECHANICAL AND/OR LIGHTING AT CEILING. SEE M&E SHEETS.
05	SCRAPE AND REMOVE LOOSE PAINT AT FLOOR.
06	REMOVE ALL FURNITURE, COORDINATE RELOCATION/DISPOSAL WITH OWNER. REMOVE AND DISPOSE OF DEBRIS.
07	RELOCATE WALL-MOUNT HEATER TO AVOID NEW WALL CONSTRUCTION. COORDINATE NEW LOCATION WITH MECHANICAL AND ELECTRICAL, RE-INSTALL.
08	REMOVE EXISTING METAL RACKS. COORDINATE RE-USE/RELOCATION/DISPOSAL WITH OWNER.
09	REMOVE FLOORING AT NEW WALL LOCATION. SEE SHEET A-101.
10	REMOVE EXISTING FLOORING, UP TO AND INCLUDING NEW WALL LOCATION, WHERE APPLICABLE.
14	EXISTING WOOD FLOORING TO REMAIN.
15	EXISTING CEILING GRID AND TILES TO BE REMOVED, AND DISPOSED OF.
16	EXISTING DOOR AND HARDWARE TO BE REMOVED AND DISPOSED OF, EXISTING CASED OPENING TO REMAIN.



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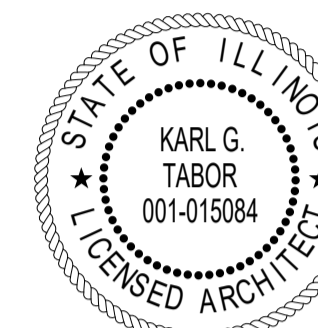
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DEMOLITION PLANS

**D-101**



SIGNATURE: *Karl G. Taber*  
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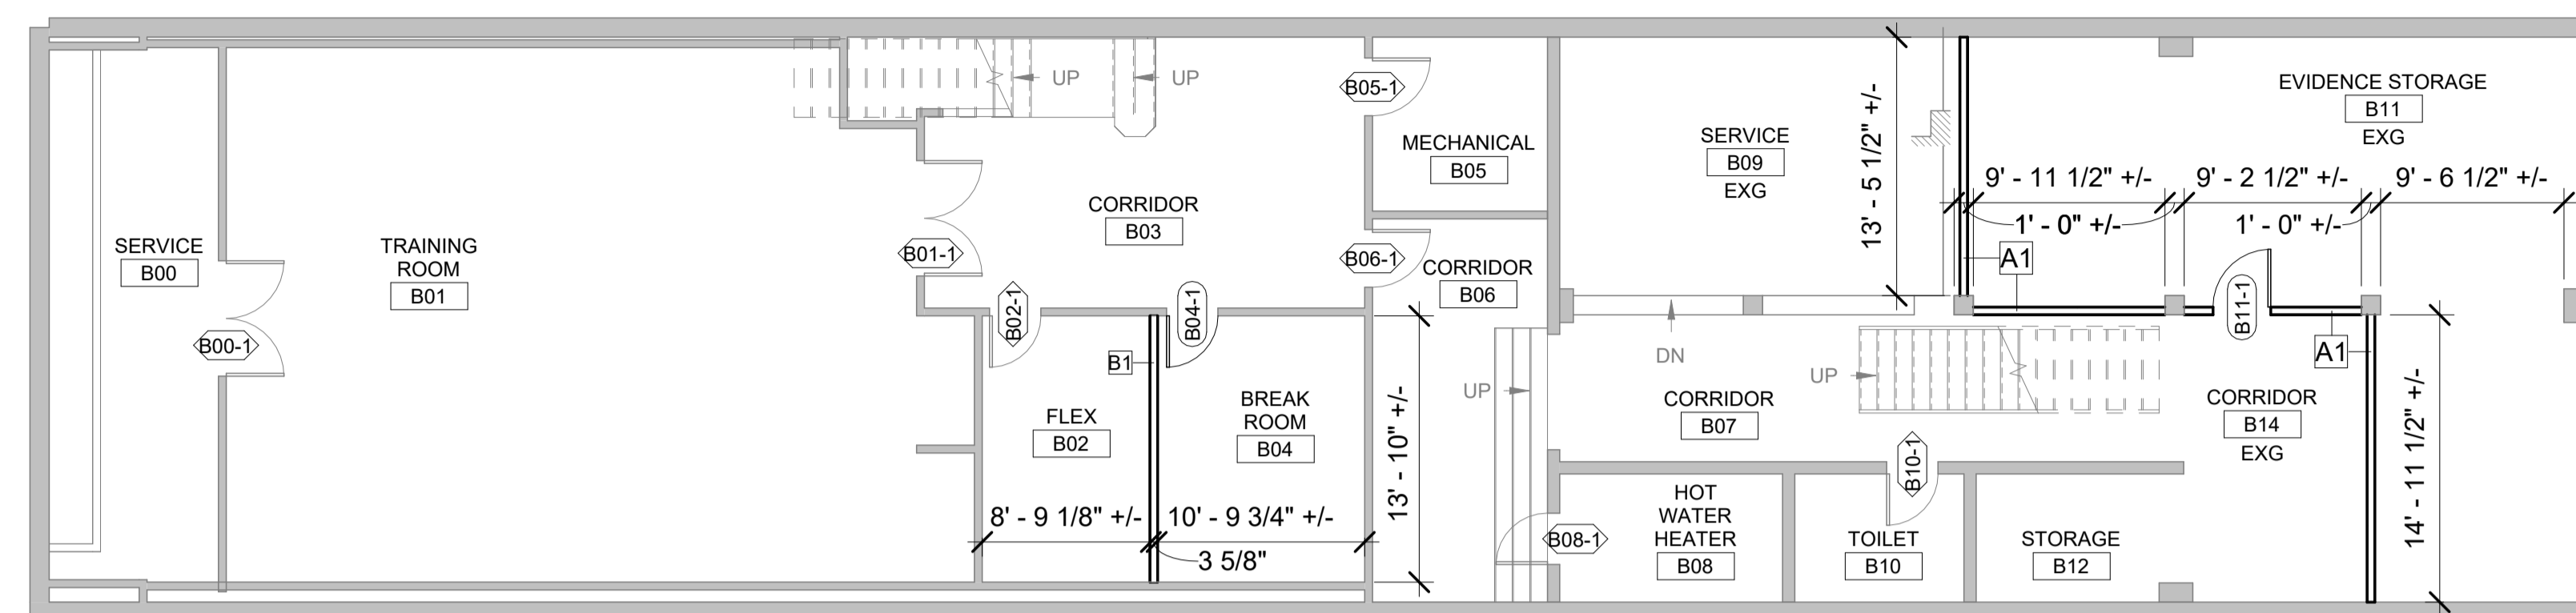
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**GENERAL NOTES (THIS SHEET ONLY)**


- DIMENSIONS TO EXISTING WALLS ARE TO FACE OF EXISTING FINISH. TO BE CONSIDERED +/-.
- DIMENSIONS TO NEW WALLS ARE TO FACE OF NEW STUD.

**KEYNOTE LEGEND**

MARK	KEYNOTE
14	EXISTING WOOD FLOORING TO REMAIN.
16	EXISTING DOOR AND HARDWARE TO BE REMOVED AND DISPOSED OF, EXISTING CASED OPENING TO REMAIN.
204	PROVIDE NEW COUNTERTOP - SEE SPECS.
205	PROVIDE NEW 4" BACKSPLASH/SIDESPLASH - SEE SPECS.
206	PROVIDE NEW COUNTEROP SUPPORT BRACKETS, SPACED @ 2'-0" O.C. MAX. - SEE SPECS.
207	PROVIDE NEW IN-WALL BLOCKING AT NEW WALL.
208	PROVIDE NEW 2X WOOD LEDGER.
209	PROVIDE END SUPPORT PANEL - SEE SPECS.
210	PROVIDE CARD READER.




**1 NEW - BASEMENT FLOOR PLAN**

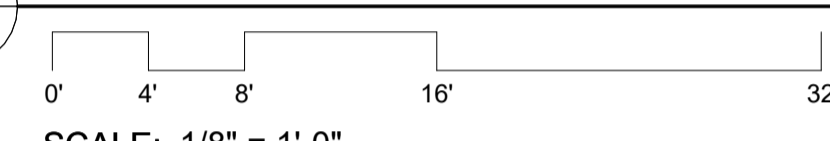


SCALE: 1/8" = 1'-0"

NEW FLOORING AT: ROOM B01 - CARPET TILE (1020 +/- SF)  
 ROOM B11, B14 - PAINT CONC. FLOOR (TOTAL 888 +/- SF)


SEE ROOM FINISH SCHEDULE, A-601

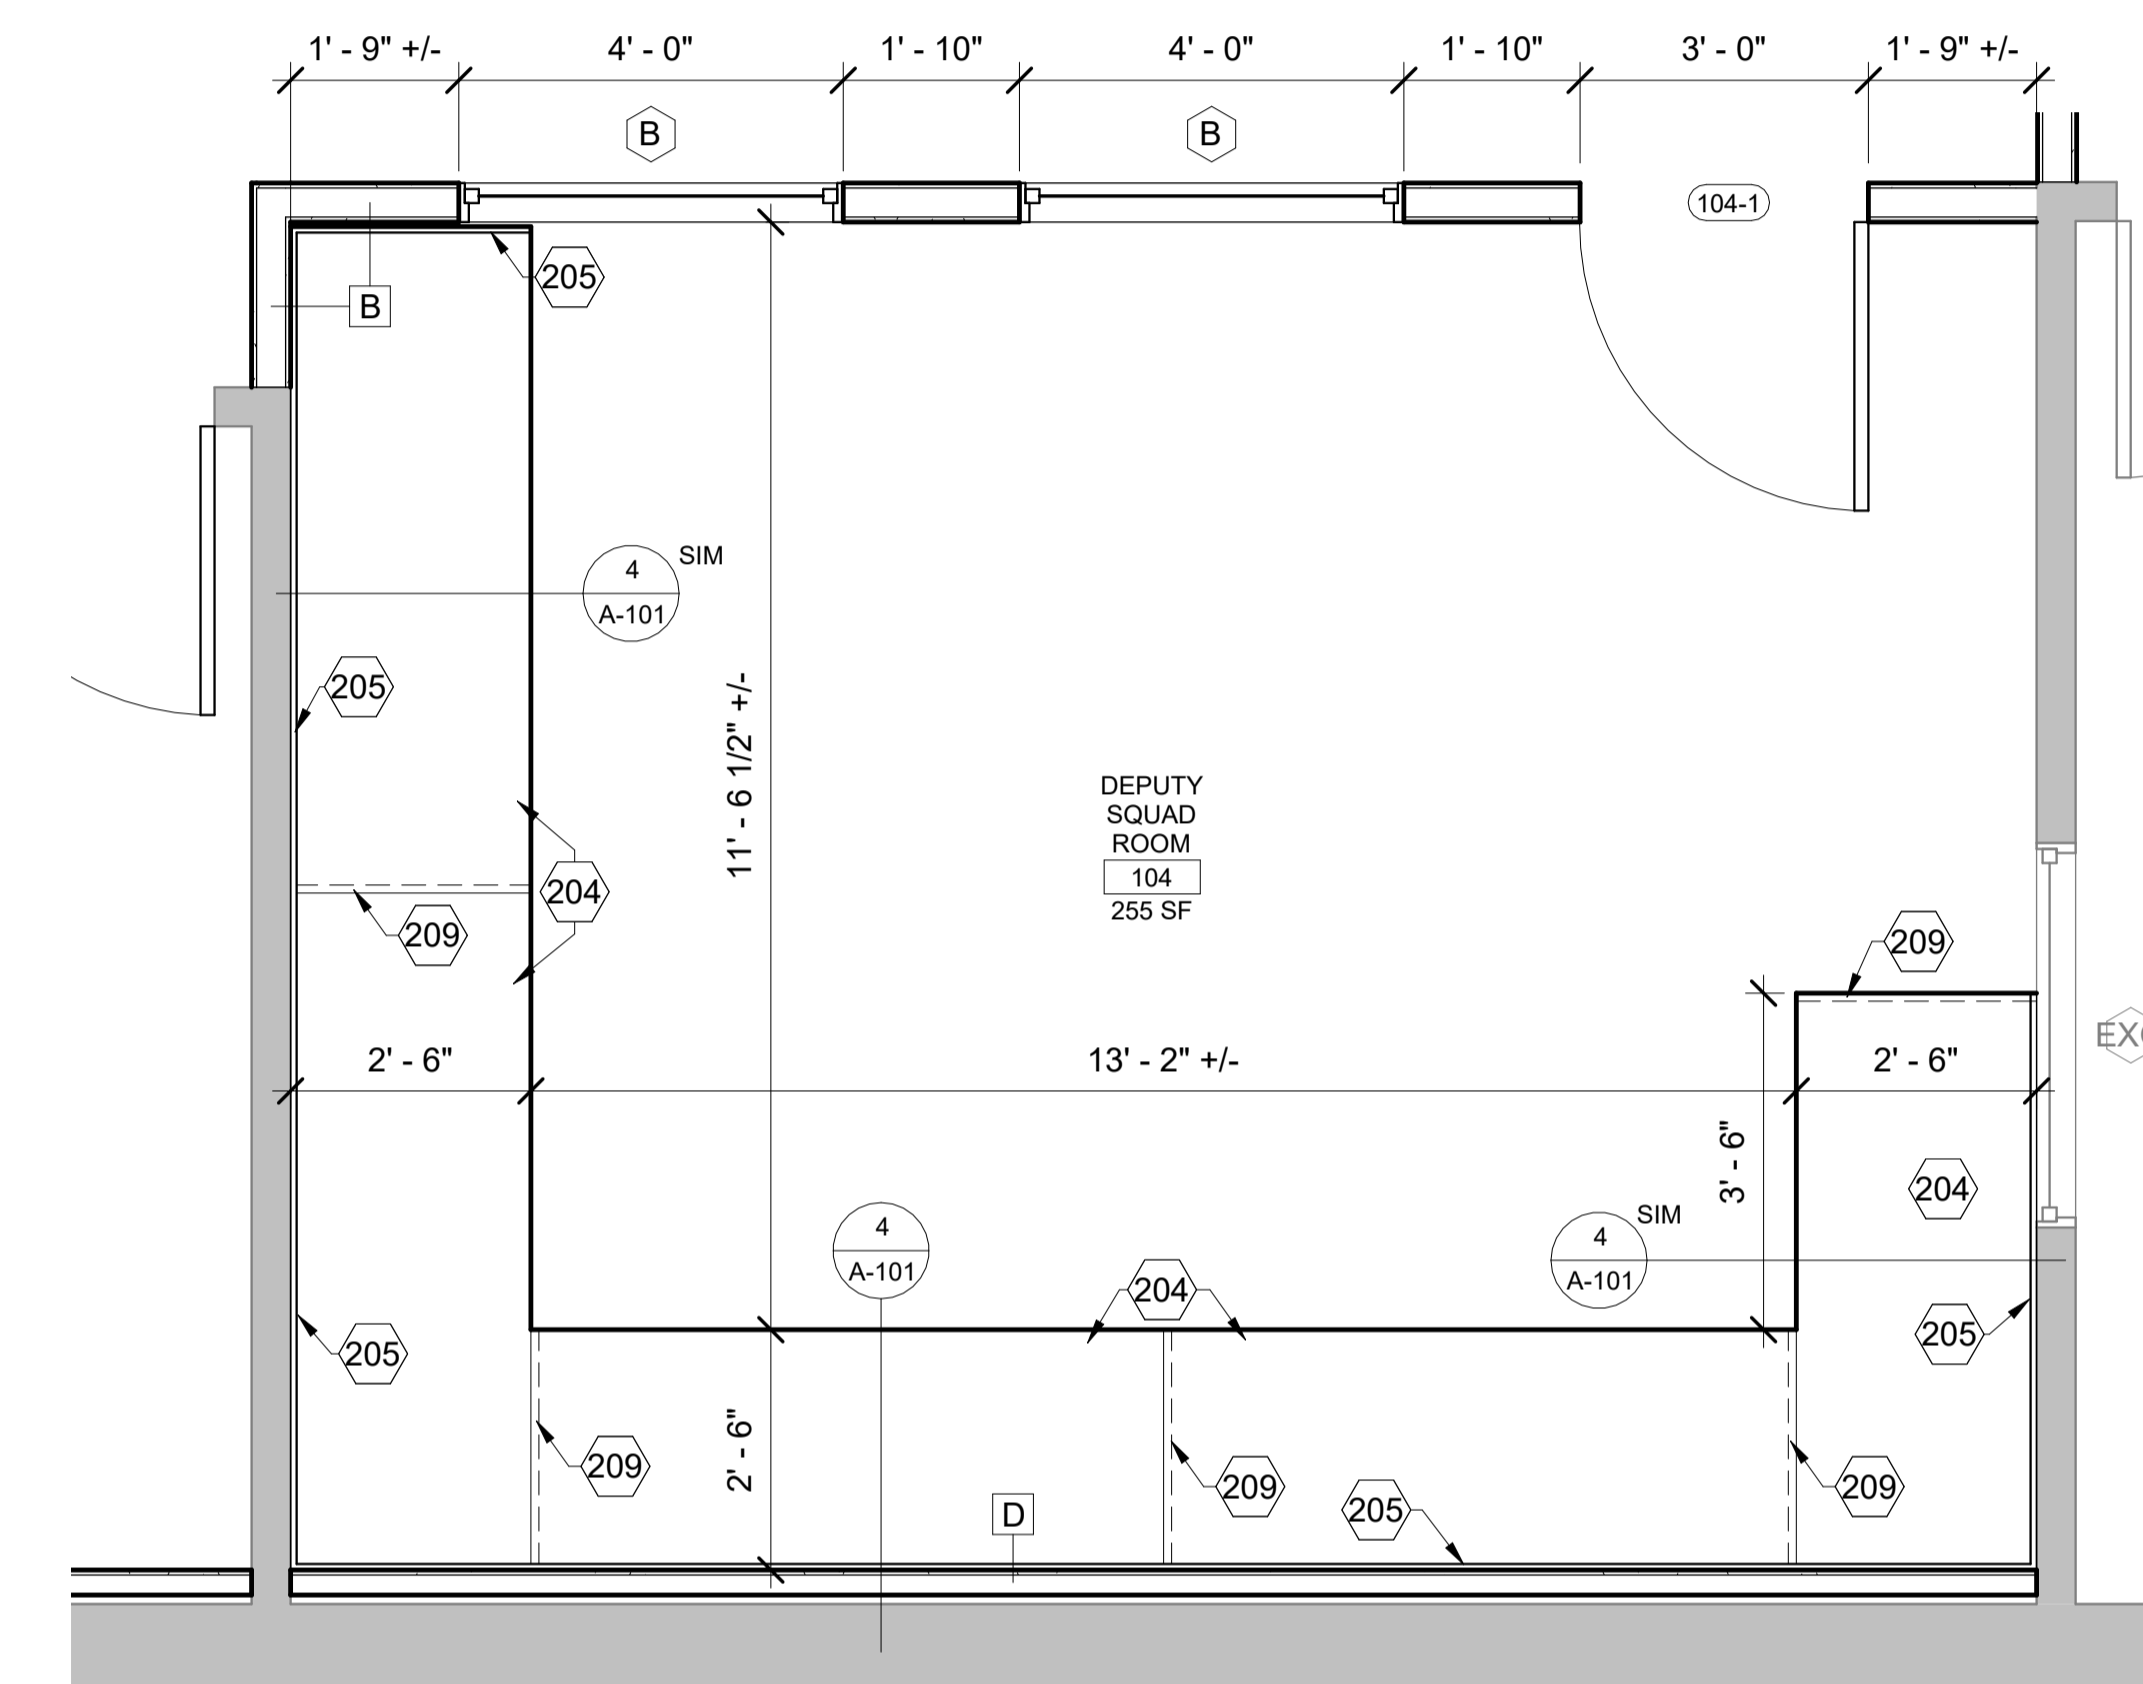

**3 LARGE SCALE PLAN - 104**

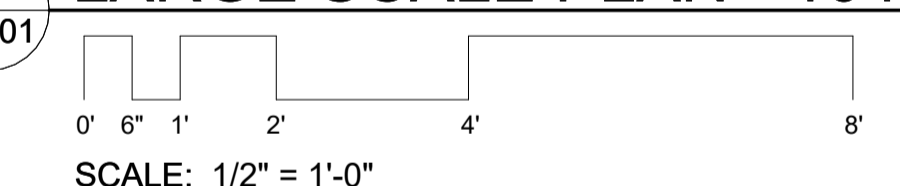


SCALE: 1/2" = 1'-0"

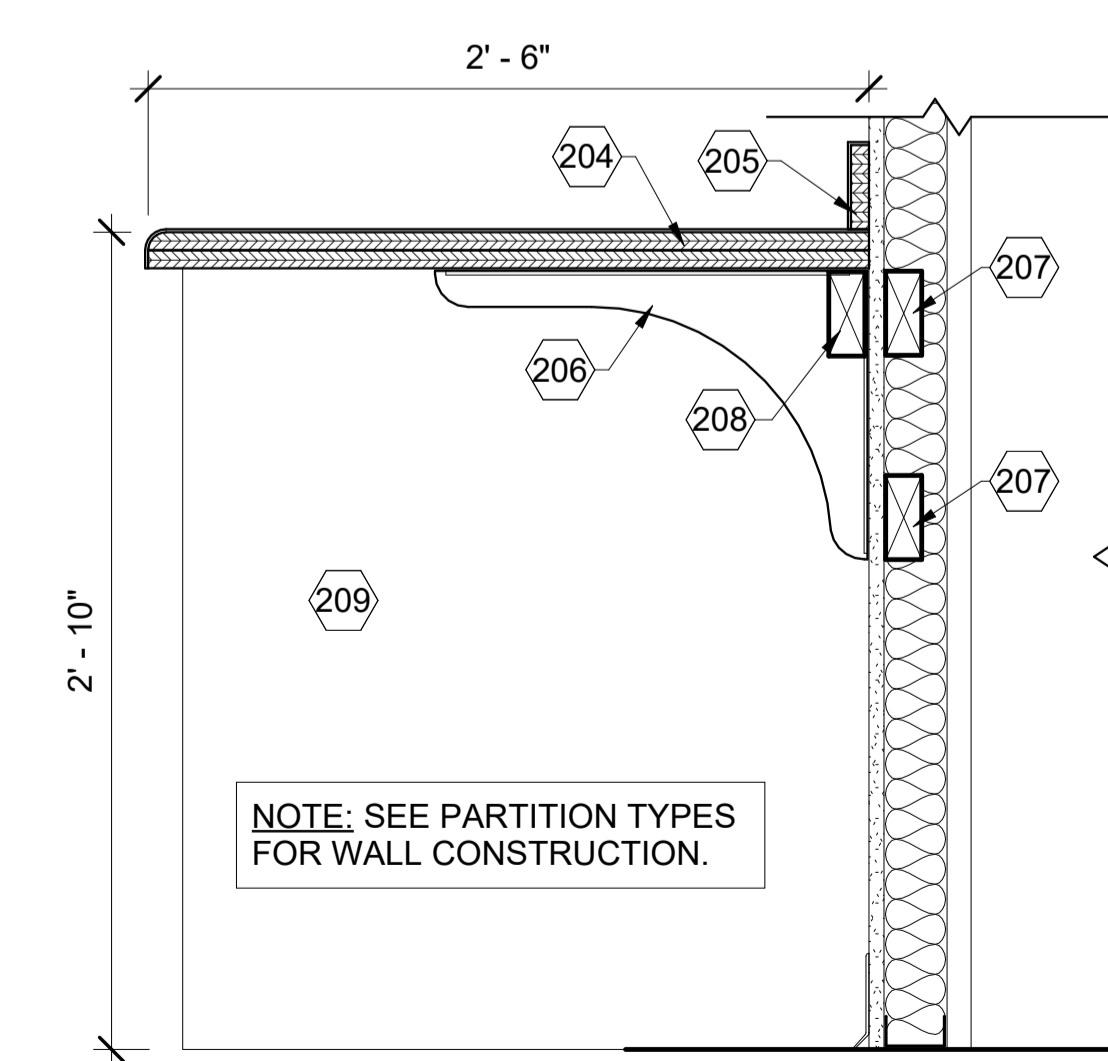


**4 TYP. SECTION AT COUNTERTOP**

SCALE: 1 1/2" = 1'-0"

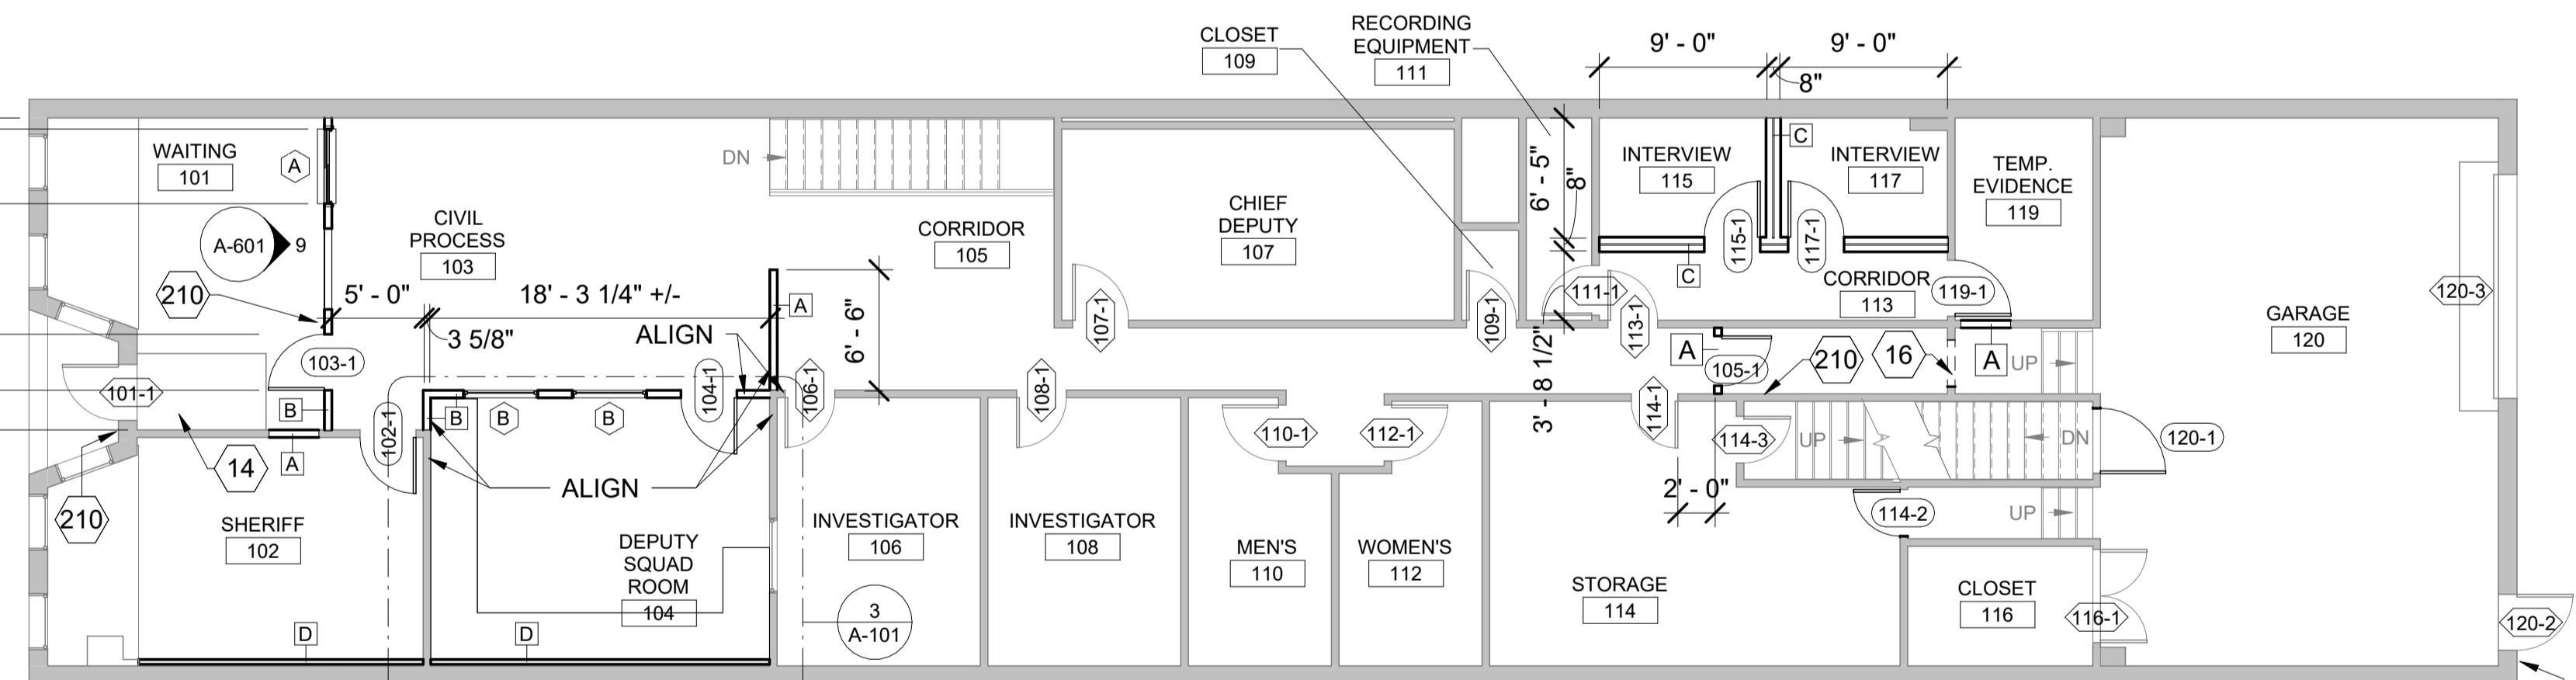

**2 NEW - FIRST FLOOR PLAN**

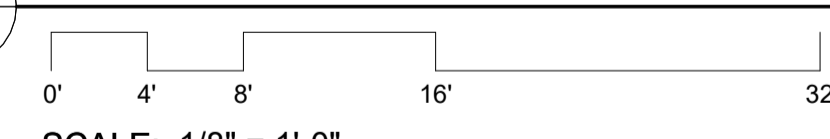

SCALE: 1/8" = 1'-0"

NEW FLOORING AT: ROOM 101 (150 +/- SF)  
 ROOM 102 (188 +/- SF)  
 ROOM 104 (255 +/- SF)  
 ROOM 106 (155 +/- SF)  
 ROOM 107 (215 +/- SF)  
 ROOM 108 (150 +/- SF)  
 ROOM 113, 115, 117 (TOTAL 200 +/- SF)

SEE ROOM FINISH SCHEDULE, A-601

**KEY LEGEND**

- NEW DOOR
- EXG DOOR
- WINDOW
- PARTITION TYPE
- ROOM NAME
- ROOM NUMBER
- ROOM AREA (SQUARE FEET)
- DETAIL NUMBER
- SHEET NUMBER


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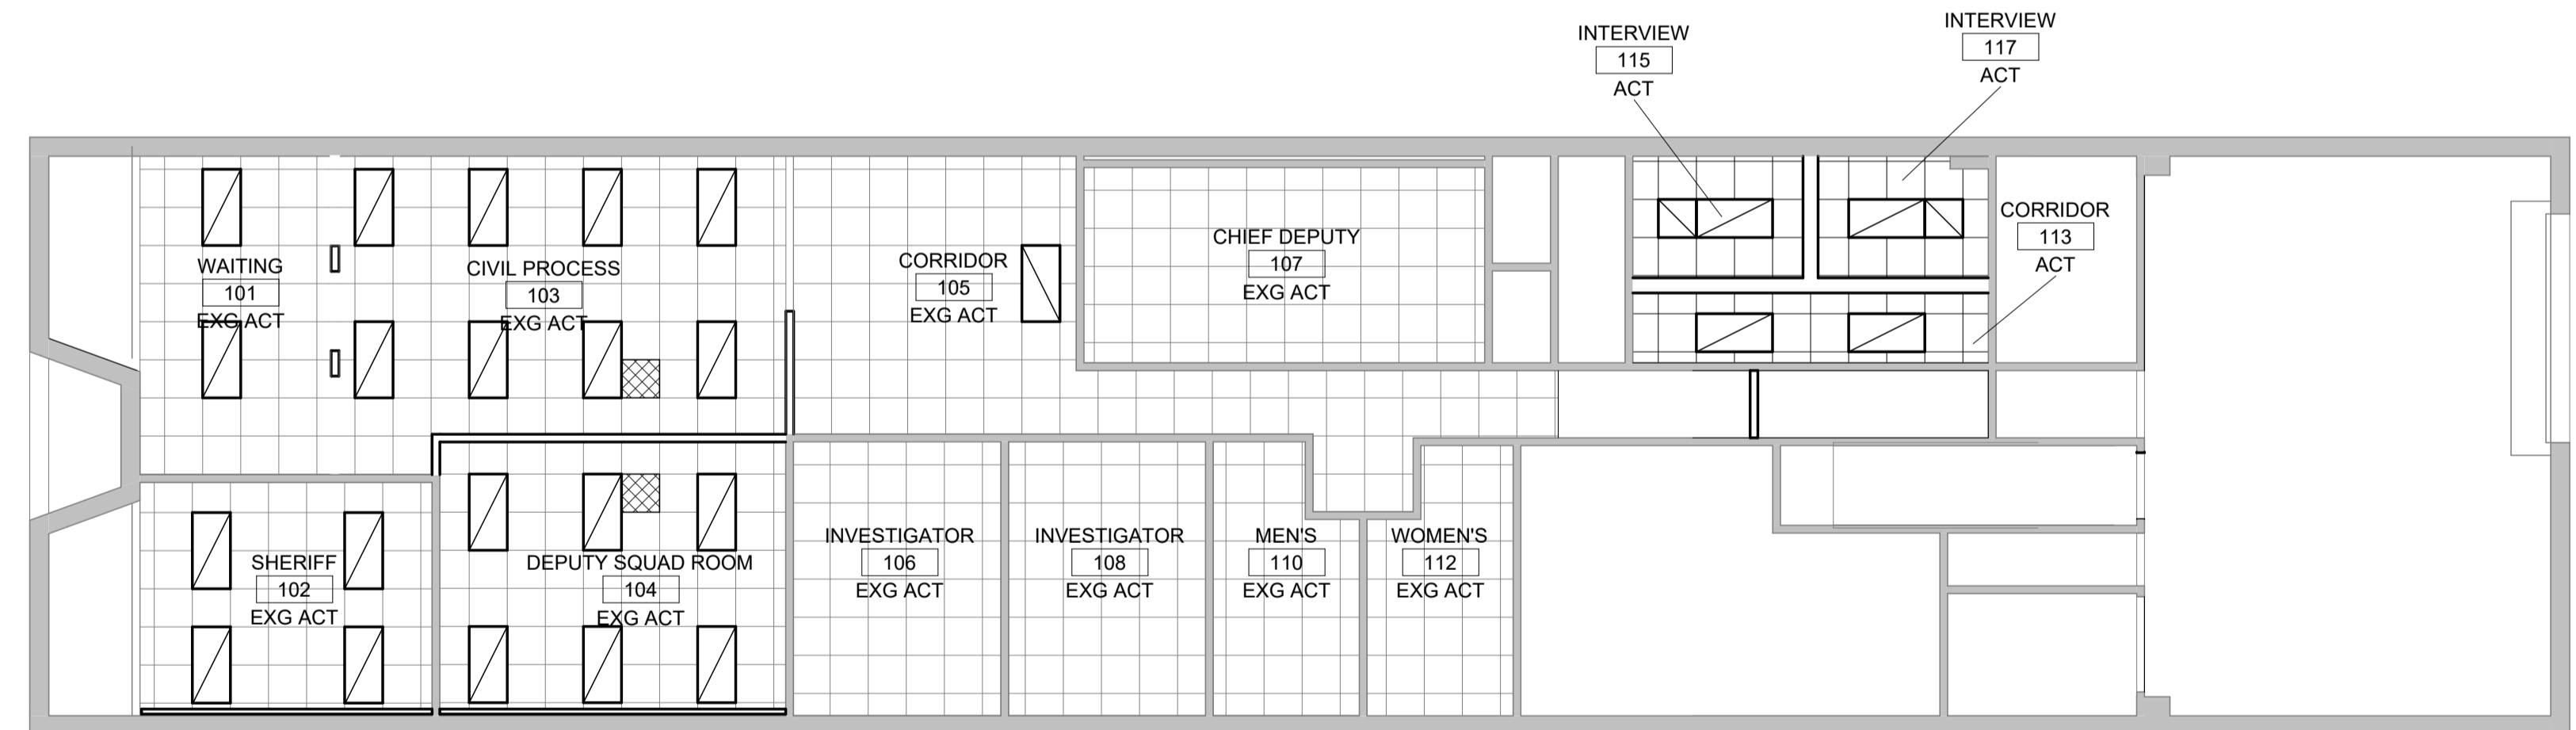
**NEW FLOOR PLANS**



SIGNATURE: *Karl G. Taber*  
 DATE: 03.15.2024  
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**1**  
**A-110**  
**BASEMENT REFLECTED CEILING PLAN**  
 N  
 0' 4' 8' 16' 32'  
 SCALE: 1/8" = 1'-0"



**2**  
**A-110**  
**FIRST FLOOR REFLECTED CEILING PLAN**  
 N  
 0' 4' 8' 16' 32'  
 SCALE: 1/8" = 1'-0"

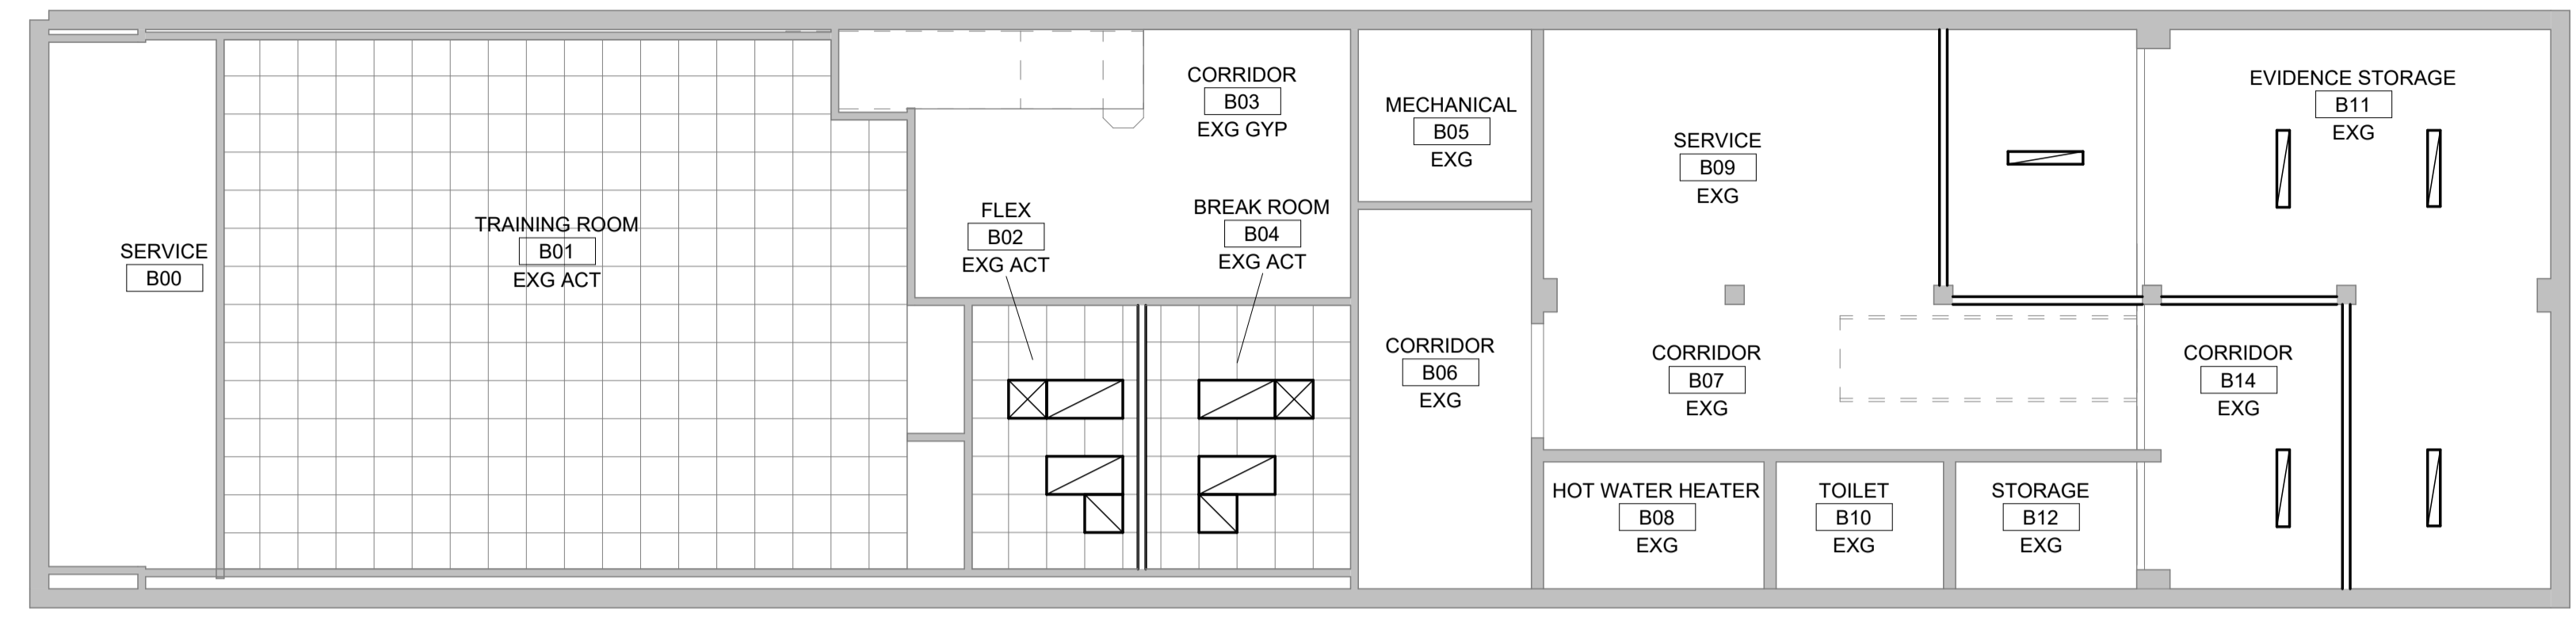**KEY LEGEND**

ROOM	←	ROOM NAME
101	←	ROOM NUMBER
A.C.T.	←	CEILING FINISH
10'-0"	←	CEILING HEIGHT
<b>1</b>	←	DETAIL NUMBER
<b>A-101</b>	←	SHEET NUMBER
	←	EXG. CLG. TILE
	←	NEW CLG. TILE
	←	ELECTRICAL - LIGHT FIXTURE
	←	HVAC - SUPPLY
	←	HVAC - RETURN AIR
	←	TRANSFER GRILLE

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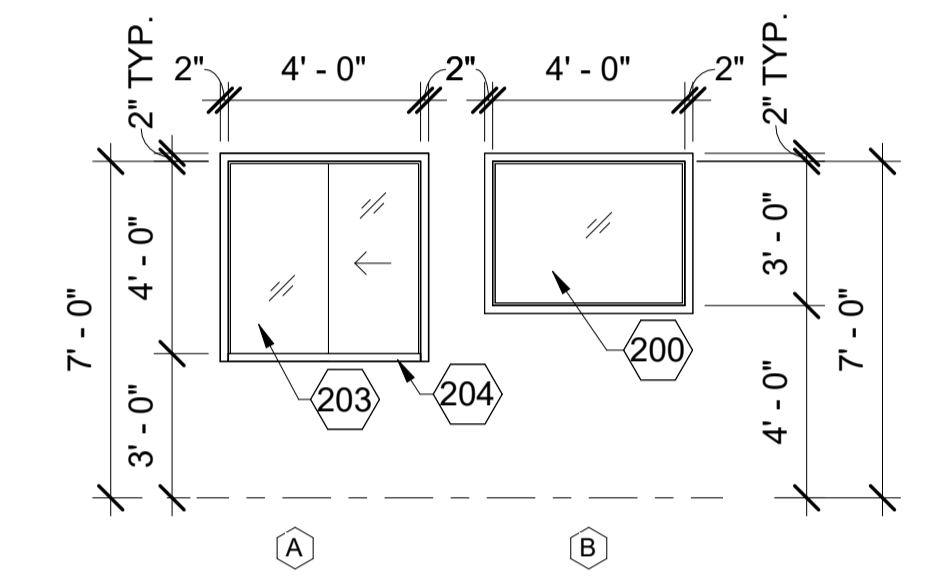
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**REFLECTED CEILING PLANS**

**A-110**


DOOR SCHEDULE - NEW (101)																
DOOR NO.	STATUS	WIDTH	HEIGHT	THICKNESS	DOOR			FRAME		DETAILS		FIRE RATING	HARDWARE GROUP	STC RATING		
					MATERIAL	FINISH	ELEV.	MATERIAL	FINISH	ELEV.	HEAD	JAMB				
102-1	NEW	3'-0"	7'-0"	1 3/4"	WOOD	STN	A	TEMP.	HM	PT	F1	H1	J1	-	07.01	-
103-1	NEW	3'-0"	7'-0"	1 3/4"	WOOD	STN	A	TEMP.	HM	PT	F1	H1	J1	-	02.02	-
104-1	NEW	3'-0"	7'-0"	1 3/4"	WOOD	STN	A	TEMP.	HM	PT	F1	H1	J1	-	05.03	-
105-1	NEW	2'-8"	7'-0"	1 3/4"	WOOD	STN	A	TEMP.	HM	PT	F1	H1	J1	-	02.01	-
114-2	NEW	2'-6"	7'-0"	1 3/4"	WOOD	STN	A	-	HM	PT	F1	H1	J1	-	09.03	-
115-1	NEW	3'-0"	7'-0"	1 3/4"	WOOD	STN	B	-	HM	PT	F1	H2	J2	-	05.02	60
117-1	NEW	3'-0"	7'-0"	1 3/4"	WOOD	STN	B	-	HM	PT	F1	H2	J2	-	05.02	60
119-1	NEW	3'-0"	7'-0"	1 3/4"	WOOD	STN	B	-	HM	PT	F1	H1	J1	-	09.03	-
120-1	NEW	3'-6"	7'-0"	1 3/4"	HM	PT	B	-	HM	PT	F1	H1	J1	-	09.02	-
B04-1	NEW	2'-8"	7'-0"	1 3/4"	HM	PT	A	TEMP.	HM	PT	F1	H1	J1	-	05.01	-
B11-1	NEW	3'-0"	7'-0"	1 3/4"	HM	PT	B	-	HM	PT	F1	H1	J1	-	09.01	-

DOOR SCHEDULE - EXISTING (101)							
DOOR NO.	STATUS	WIDTH	HEIGHT	THICKNESS	MATERIAL		HARDWARE GROUP
					DOOR	FRAME	
101-1	EXG	3'-0"	7'-0"	1 3/4"	AL/GL	AL	00.2
106-1	EXG	2'-8"	7'-0"	1 3/4"	WD	HM	00.7
107-1	EXG	3'-0"	7'-0"	1 3/4"	WD	HM	00.7
108-1	EXG	2'-8"	7'-0"	1 3/4"	WD	HM	00.7
111-1	EXG	2'-8"	7'-0"	1 3/8"	WD	WD	00.6
113-1	EXG	2'-8"	7'-0"	1 3/4"	WD	WD	00.5
120-2	EXG	3'-0"	7'-0"	1 3/4"	HM	HM	00.3
B02-1	EXG	2'-8"	7'-0"	1 3/4"	HM	HM	00.7
109-1	EXG	2'-8"	7'-0"	1 3/4"	N/A	N/A	00.1
110-1	EXG	3'-0"	7'-0"	1 3/4"	N/A	N/A	00.1
112-1	EXG	3'-0"	7'-0"	1 3/4"	N/A	N/A	00.1
114-1	EXG	2'-6"	7'-0"	1 3/4"	N/A	N/A	00.1
114-3	EXG	2'-6"	7'-0"	1 3/4"	N/A	N/A	00.1
114-4	EXG	2'-6"	7'-0"	1 3/4"	N/A	N/A	00.1
116-1	EXG	5'-0"	7'-0"	1 3/4"	N/A	N/A	00.1
120-3	EXG	12'-0"	14'-0"	3"	N/A	N/A	00.1
B00-1	EXG	6'-0"	7'-0"	1 3/4"	N/A	N/A	00.1
B01-1	EXG	6'-0"	7'-0"	1 3/4"	N/A	N/A	00.1
B05-1	EXG	3'-0"	7'-0"	1 3/4"	N/A	N/A	00.1
B06-1	EXG	3'-0"	7'-0"	1 3/4"	N/A	N/A	00.1
B08-1	EXG	2'-8"	7'-0"	1 3/4"	N/A	N/A	00.1
B10-1	EXG	2'-8"	7'-0"	1 3/4"	N/A	N/A	00.1




2 WINDOW ELEVATIONS  
SCALE: 1/4" = 1'-0"


WINDOW SCHEDULE (A)									
WINDOW NO.	WIDTH	HEIGHT	FRAME MATERIAL	ELEV.	DETAILS			GLAZING	
					HEAD	JAMB	SILL		
A	4'-0"	4'-0"	HM	A	H5	J5	S5	SLIDING GLASS	
B	4'-0"	3'-0"	HM	B	H4	J4	S4	TEMPERED	

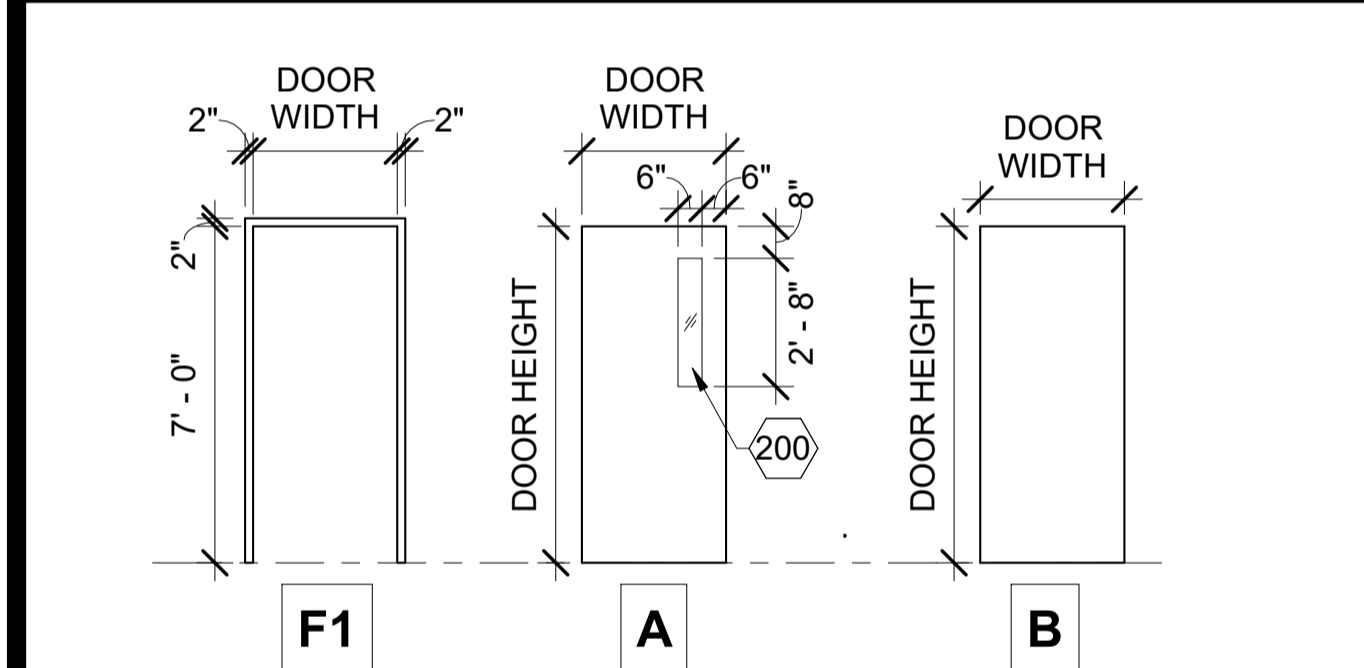


1 DOOR AND FRAME ELEVATIONS  
SCALE: 1/4" = 1'-0"

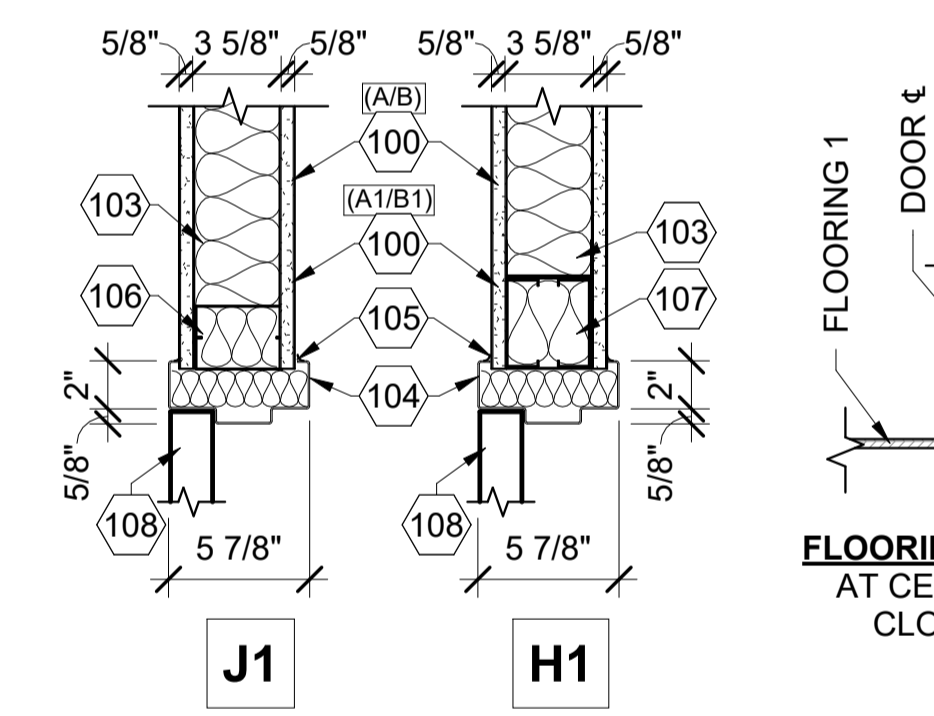


3 DOOR DETAILS  
SCALE: 1 1/2" = 1'-0"

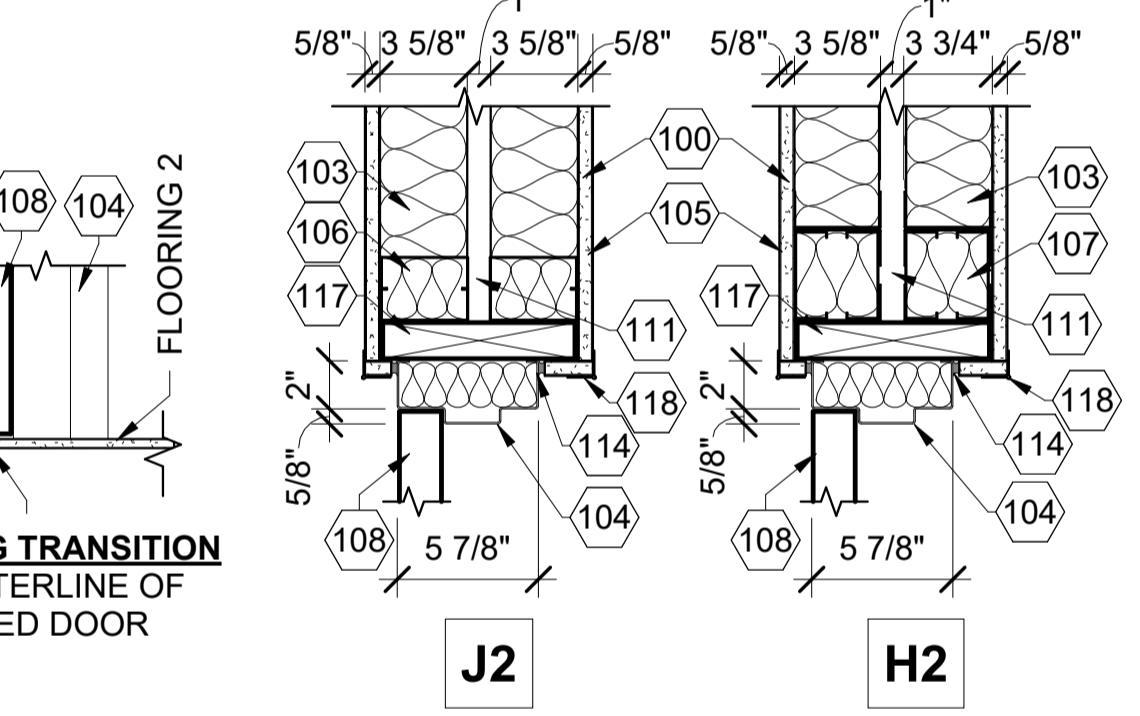


4 WINDOW DETAILS  
SCALE: 1 1/2" = 1'-0"

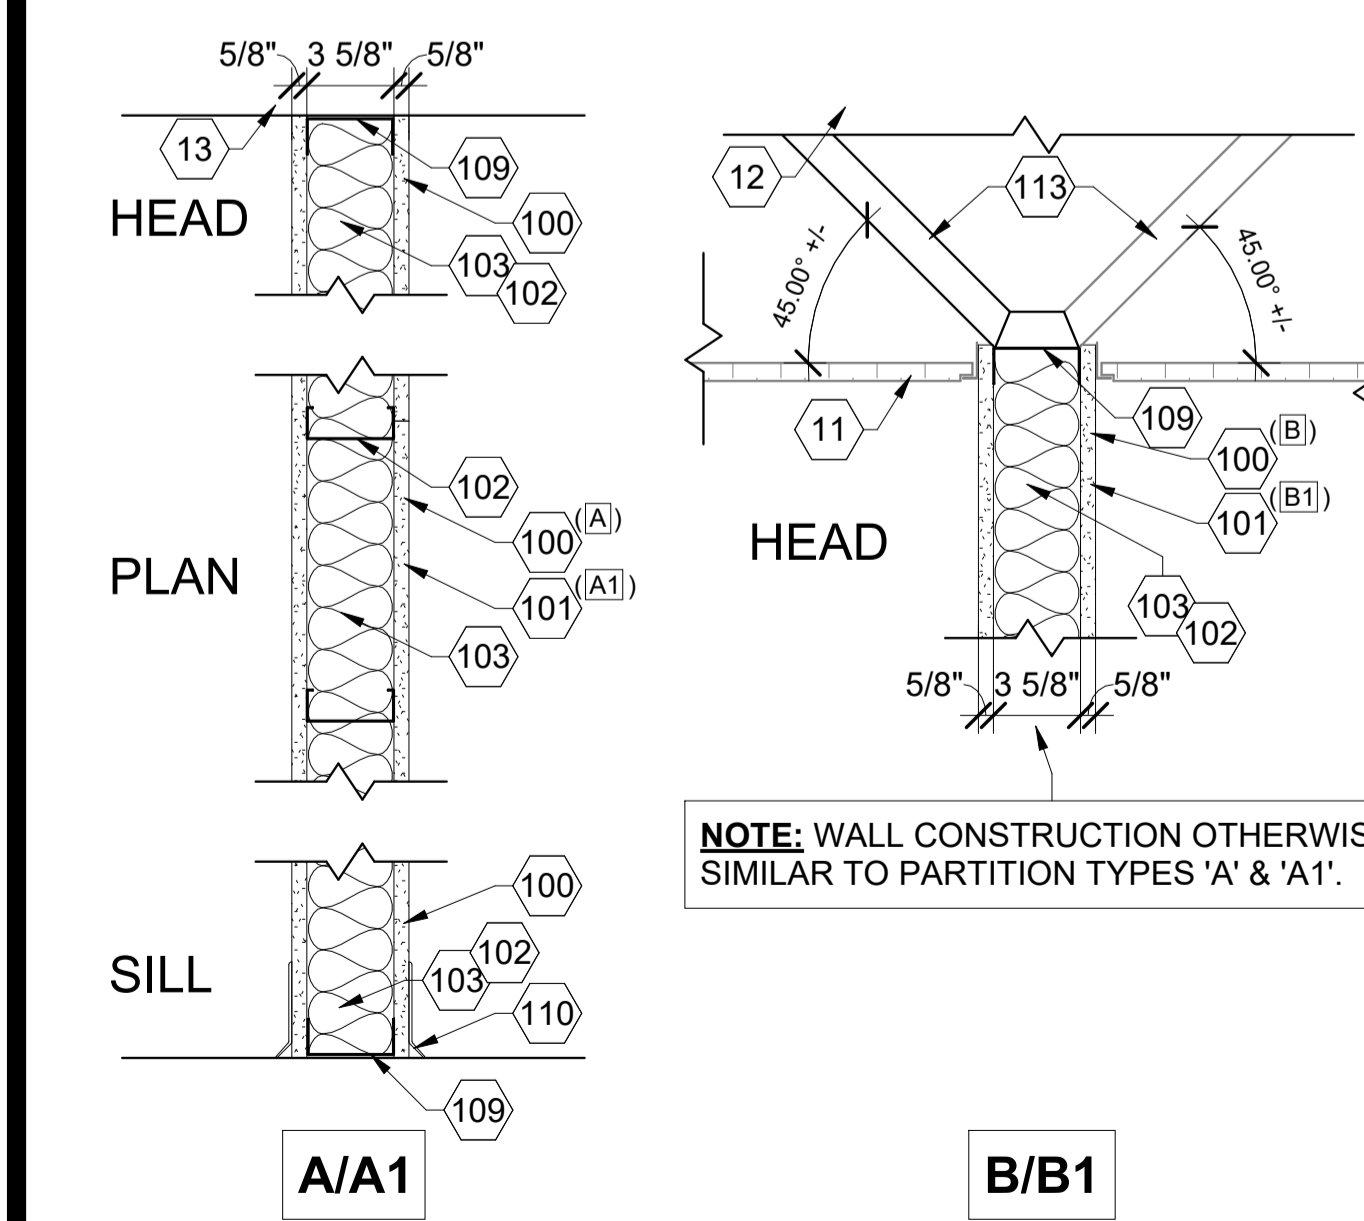

5 PARTITION TYPES  
SCALE: 1 1/2" = 1'-0"

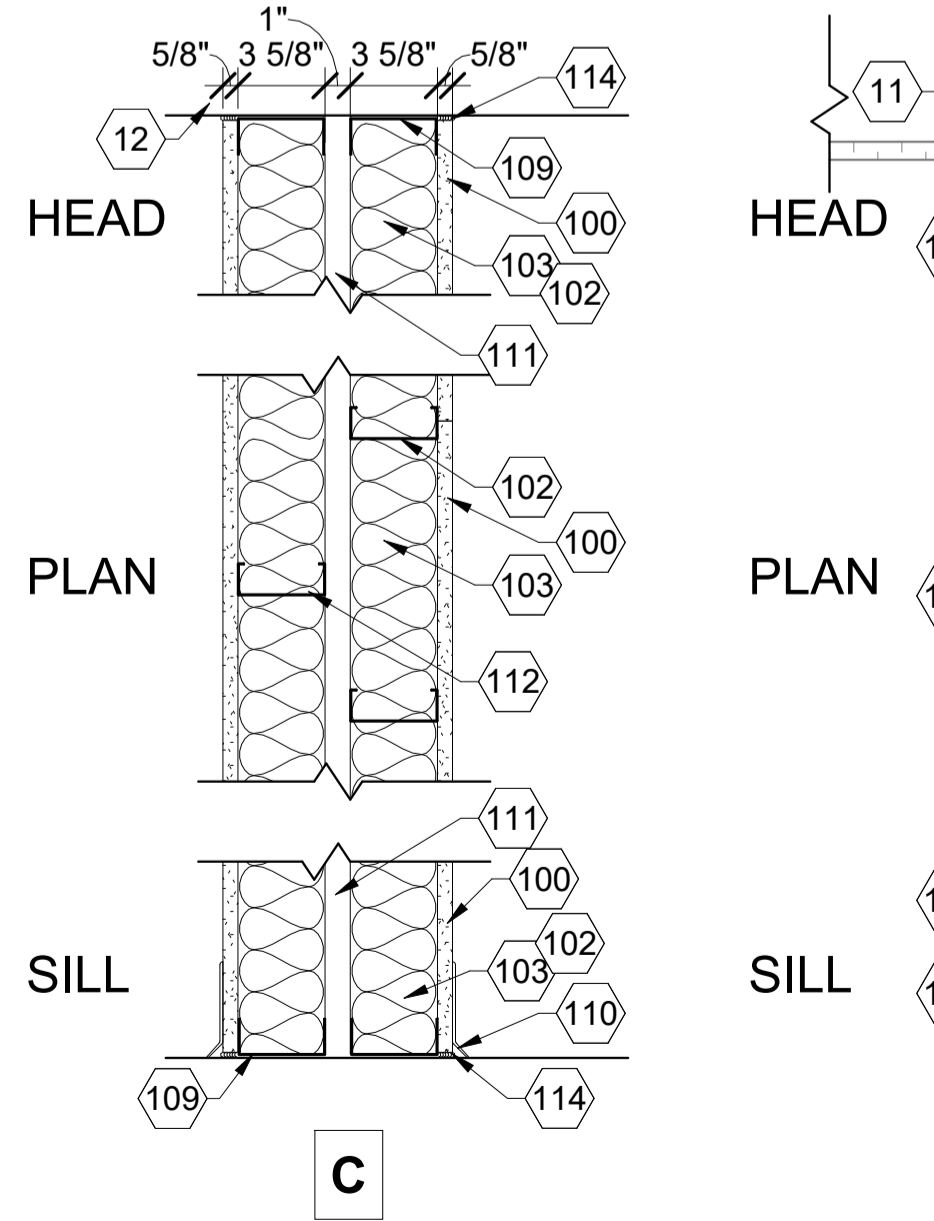

NOTE: WALL CONSTRUCTION OTHERWISE SIMILAR TO PARTITION TYPE 'B'.  
NOTE: SEE ELECTRICAL SHEETS FOR EXISTING RECEPTACLES' RELOCATION.

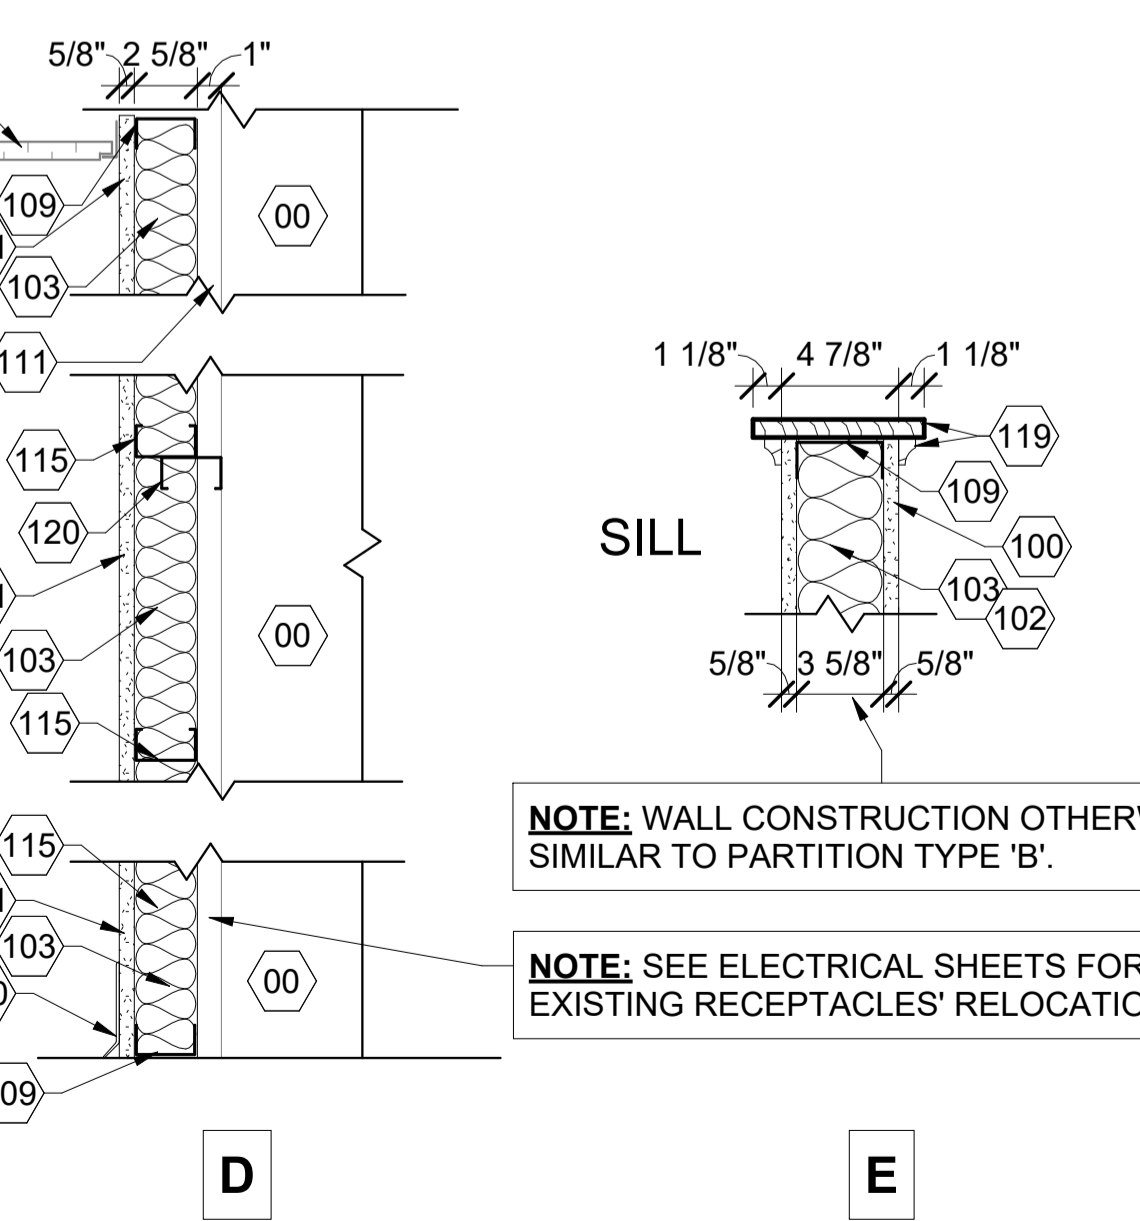

9 INTERIOR ELEVATION - WAITING  
SCALE: 1/2" = 1'-0"

ROOM FINISH SCHEDULE													
ROOM NO.	ROOM NAME	FLOOR	BASE	WALLS				CEILING		COMMENTS			
				NORTH	EAST	SOUTH	WEST	FINISH	HEIGHT				
101	WAITING	CPT	RB	PT	PT	PT	PT	EXG ACT	10'-10"				
102	SHERIFF	CPT	RB	PT	PT	PT	PT	EXG ACT	10'-10"				
103	CIVIL PROCESS	-	-	-	-	-	-	EXG ACT	10'-10"				
104	DEPUTY SQUAD ROOM	CPT	RB	PT	PT	PT	PT	EXG ACT	10'-10"				
105	CORRIDOR	-	-	-	-	-	-	EXG ACT	7'-11" & 7'-8"				
106	INVESTIGATOR	CPT	RB	PT	PT	PT	PT	EXG ACT	7'-11"				
107	CHIEF DEPUTY	CPT	RB	PT	PT	PT	PT	EXG ACT	7'-11"				
108	INVESTIGATOR	CPT	RB	PT	PT	PT	PT	EXG ACT	7'-11"				
109	CLOSET	-	-	-	-	-	-	EXG ACT	8'-1"				
110	MEN'S	-	-	-	-	-	-	EXG ACT	7'-11"				
111	RECORDING EQUIPMENT	-	-	-	-	-	-	EXG ACT	10'-8"				
112	WOMEN'S	-	-	-	-	-	-	EXG ACT	7'-11"				
113	CORRIDOR	CPT	RB	PT	PT	PT	PT	ACT	7'-11 1/2"				
114	STORAGE	-	-	-	-	-	-	ACT	7'-8"				
115	INTERVIEW	CPT	RB	PT	PT	PT	PT	ACT	7'-11 1/2"				
116	CLOSET	-	-	-	-	-	-	ACT	-				
117	INTERVIEW	CPT	RB	PT	PT	PT	PT	ACT	7'-11 1/2"				
119	TEMP. EVIDENCE	-	-	-	-	-	-	-	-				
120	GARAGE	-	-	-	-	-	-	-	-				
B00	SERVICE	-	-	-	-	-	-	-	-				
B01	TRAINING ROOM	CPT	RB	-	-	-	-	EXG ACT	7'-6"				
B02	FLEX	-	RB	PT	PT	PT	PT	EXG ACT	7'-7"				
B03	CORRIDOR	-	-	-	-	-	-	EXG GYP	7'-7"				
B04	BREAK ROOM	-	RB	PT	PT	PT	PT	EXG ACT	7'-7"				
B05	EVIDENCE STORAGE	-	-	-	-	-	-	-	-				
B05	MECHANICAL	-	-	-	-	-	-	EXG	-				
B06	CORRIDOR	-	-	-	-	-	-	EXG	9'-0"				
B07	CORRIDOR	-	-	-	-	PT	-	-	-	RB AT NEW WALL			
B08	HOT WATER HEATER	-	-	-	-	-	-	EXG	-				
B09	SERVICE	-	-	-	-	-	-	EXG	-				
B10	TOILET	-	-	-	-	-	-	EXG	-				
B11	EVIDENCE STORAGE	-	-	PT	PT	-	-	EXG	-	RB AT NEW WALL			
B12	STORAGE	-	-	-	-	-	-	EXG	-				
B14	CORRIDOR	-	-	PT	-	-	-	EXG	-	RB AT NEW WALL			

KEYNOTE LEGEND	
MARK	KEYNOTE
00	EXISTING WALL CONSTRUCTION TO REMAIN.
11	EXISTING ACOUSTICAL TILE CEILING TO REMAIN AND BE REUSED.
12	EXISTING DECK CONSTRUCTION ABOVE TO REMAIN.
13	EXISTING DECK ABOVE -OR- EXISTING PLASTER CEILING -OR- TOP OF OPENING AT INFILL CONDITION.
100	PROVIDE GYP. BD TYPE 1: 5/8" TYPE 'X', ABUSE-RESISTANT GYP. BD. FINISH AND PAINT. TYP - SEE SPECS
101	PROVIDE GYP. BD TYPE 2: 5/8" MOISTURE-RESISTANT GYP. BD. FINISH AND PAINT. TYP - SEE SPECS
102	PROVIDE 3-5/8" METAL STUDS @ 16" O.C. MAX. TYP - SEE SPECS
103	PROVIDE ACOUSTIC BATT INSULATION. - SEE SPECS
104	PROVIDE NEW HOLLOW METAL DOOR FRAME. FILL WITH BATT INSULATION. - SEE DOOR SCHEDULE
105	PROVIDE CONTINUOUS SEALANT. - SEE SPECS
106	PROVIDE DOUBLE METAL STUD AT JAMB. FILL WITH BATT INSULATION.
107	PROVIDE BUILT-UP METAL BOX HEADER. FILL WITH BATT INSULATION.
108	PROVIDE NEW DOOR. - SEE DOOR SCHEDULE
109	PROVIDE NEW METAL STUD TRACK. - SEE SPECS.
110	PROVIDE NEW RUBBER BASE. - SEE SPECS
111	PROVIDE 1" AIRSPACE.
112	PROVIDE 3-5/8" METAL STUDS @ 16" O.C. MAX. STAGGERED FROM ADJACENT WALL STUDS. TYP - SEE SPECS
113	PROVIDE STAGGERED ANGLED METAL STUD KICKERS. ALTERNATE FROM SIDE-TO-SIDE OF WALL, ANCHOR TO EXISTING STRUCTURE ABOVE @ 24" O.C. MAX (OVERALL), 48" O.C. MAX (PER SIDE).
114	PROVIDE ACOUSTICAL SEALANT.
115	PROVIDE 2-1/2" METAL STUDS @ 16" O.C. MAX. TYP - SEE SPECS.
117	PROVIDE 2X WOOD BLOCKING - SEE SPECS.
118	PROVIDE CORNER BEAD.
119	PROVIDE NEW 1X HARDWOOD WALL CAP & TRIM. FINISH & COLOR TO BE SELECTED BY A/E. SEE SPECS.
120	PROVIDE METAL STUD BRACING TO BE SECURED TO EXISTING WALL WITHIN 16" OF TOP AND BOTTOM OF NEW WALL AND @ 4'-0" O.C. MAX IN EACH DIRECTION.
200	PROVIDE TEMPERED GLASS - SEE SPECS.
203	PROVIDE SLIDING GLASS WINDOW - SEE SPECS.
204	PROVIDE NEW COUNTERTOP - SEE SPECS.

**HR**

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STATE OF ILLINOIS  
KARL G. TABOR  
001-015084  
LICENSED ARCHITECT

SIGNATURE: *Karl G. Tabor*  
DATE: 03.15.2024  
11-30-2024  
LICENSE EXPIRES

NEW OFFICE  
CHRISTIAN COUNTY SHERIFF'S DEPARTMENT  
214 WEST MARKET STREET  
TAYLORVILLE, ILLINOIS 62568  
ISSUED FOR BID

MARK	DATE	DESCRIPTION

DATE: 03.15.2024  
PROJECT NO: HR-390-1533  
DESIGN: KGT  
DRAWN: CIM  
CHECK: KGT

SCHEDULES,  
ELEVATIONS, AND  
DETAILS


**A-601**

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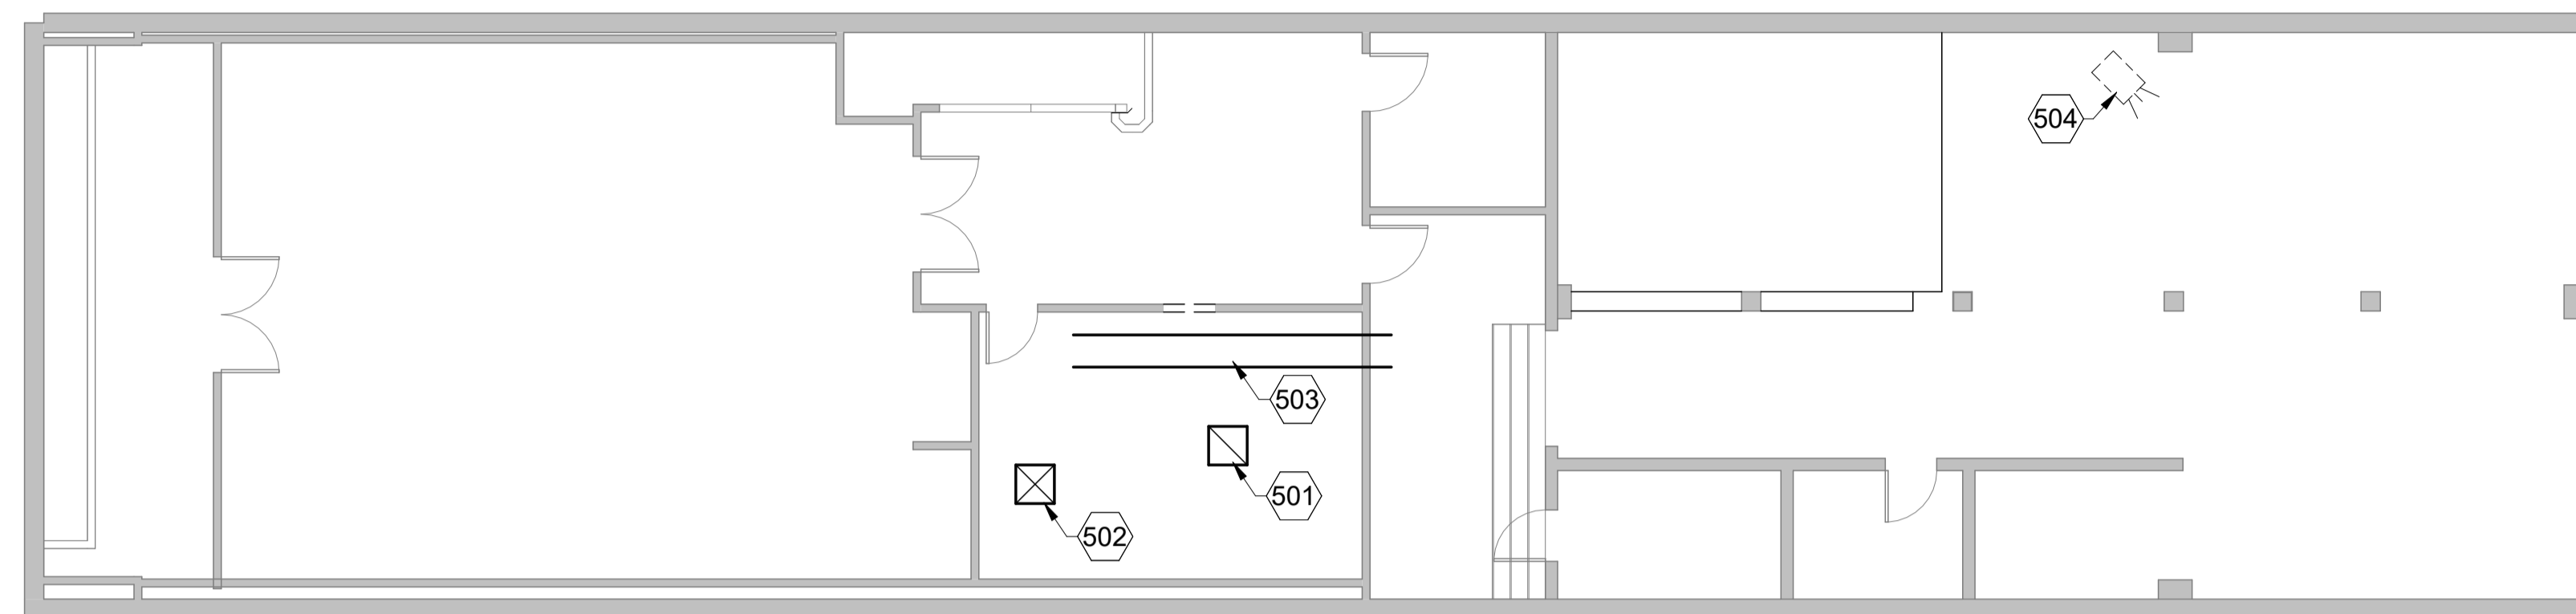
KEYNOTE LEGEND	
MARK	KEYNOTE
501	REMOVE EXISTING RETURN GRILLE.
502	REMOVE EXISTING SUPPLY GRILLE.
503	EXISTING SUPPLY DUCT TO REMAIN.
504	REMOVE EXISTING GAS FIRED UNIT HEATER. SALVAGE FOR REINSTALLATION.




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SIGNATURE: *Karl G. Tabor*  
 DATE: 03.15.2024  
 LICENSE EXPIRES: 11-30-2024

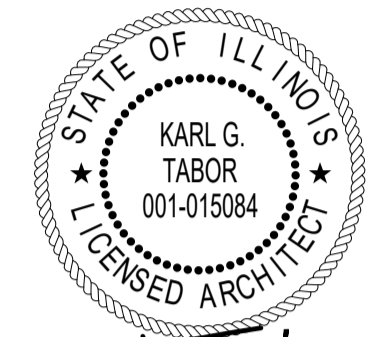

**1** BASEMENT DEMOLITION PLAN  
 MD-101  
 N  
 SCALE: 1/8" = 1'-0"



**2** FIRST FLOOR DEMOLITION PLAN  
 MD-101  
 N  
 SCALE: 1/8" = 1'-0"

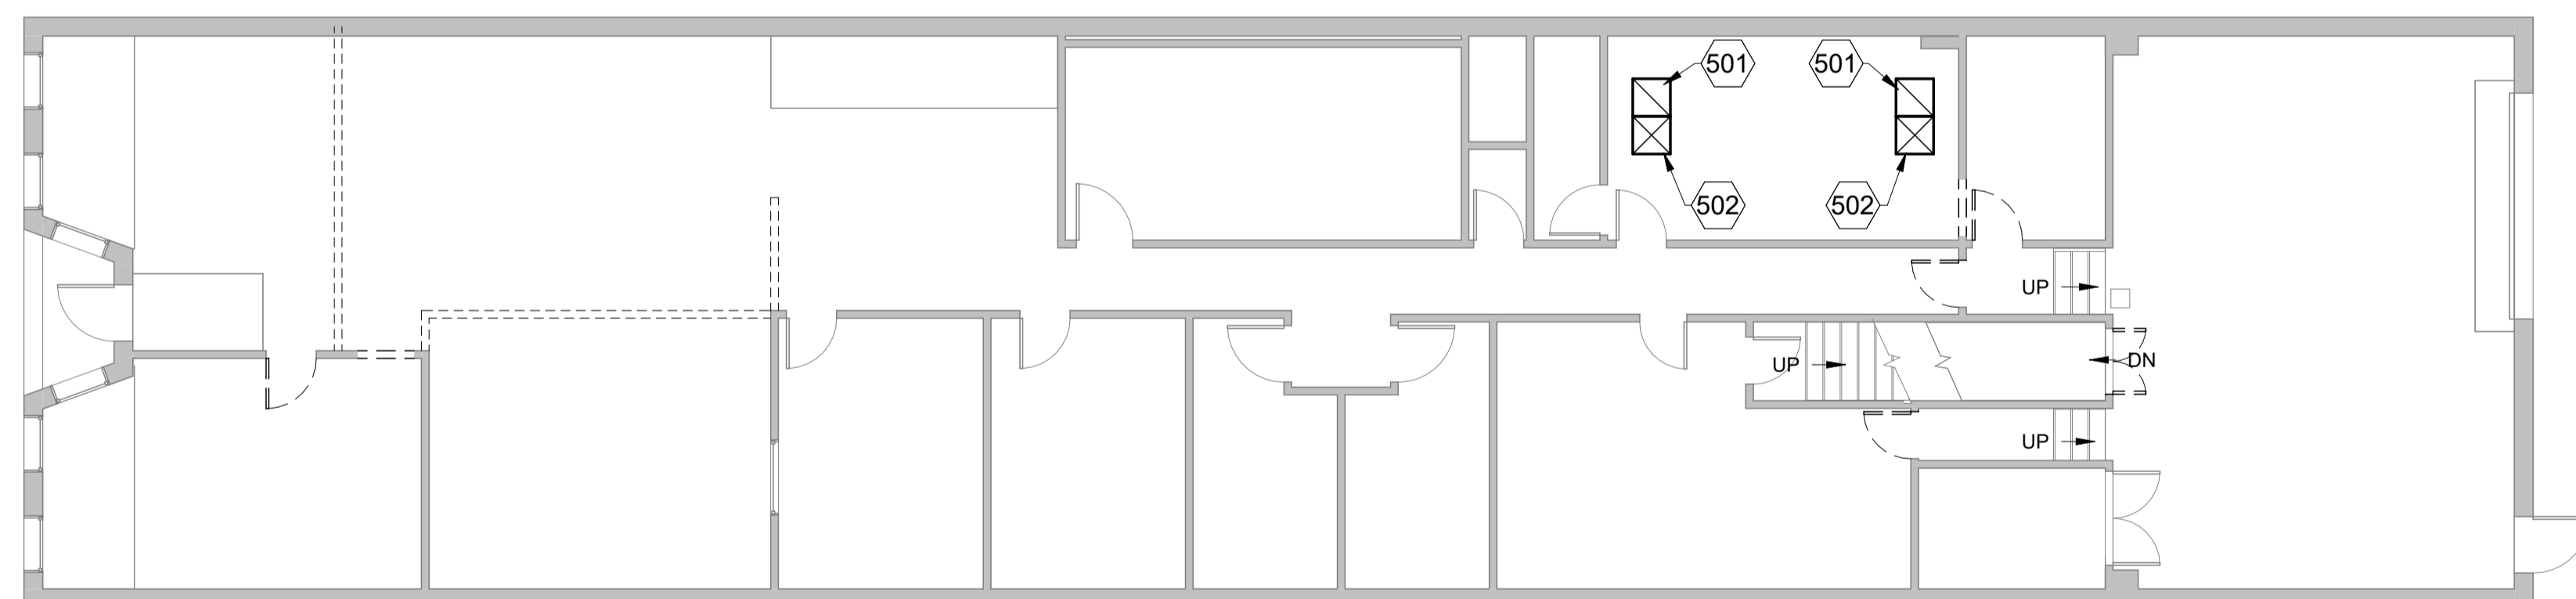**NEW OFFICE**  
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 214 WEST MARKET STREET  
 TAYLORVILLE, ILLINOIS 62568  
**ISSUED FOR BID**

MARK	DATE	DESCRIPTION

DATE: 03.15.2024  
 PROJECT NO: HR-390-1533  
 DESIGN: DRAWN: CHECK:  
 CIM

MECHANICAL  
 DEMOLITION PLANS

**MD-101**



KEYNOTE LEGEND


MARK	KEYNOTE
551	INSTALL RETURN GRILLE R-1 ON EACH SIDE OF NEW WALL. EXTEND AN 8" DIA. DUCT THROUGH WALL. CONNECT TO EACH RETURN GRILLE.
552	INSTALL RETURN GRILLE R-1.
553	INSTALL SUPPLY GRILLE S-1. CONNECT TO EXISTING SUPPLY DUCT. MODIFY AS REQUIRED.
554	INSTALL SUPPLY GRILLE S-1. EXTEND A 6" DIA. DUCT FROM THE EXISTING SUPPLY DUCT.
555	EXISTING SUPPLY DUCT TO REMAIN.
556	INSTALL DUCTLESS SPLIT WALL CASSETTE ON WALL AT 7'-6" A.F.F. EXTEND REGRIGERANT PIPING TO OUTDOOR UNIT ON ROOF IN ACCORDANCE WITH MANUFACTURER'S INSTRUCTIONS.
557	INSTALL DUCTLESS SPLIT OUTDOOR UNIT AT ROOF ABOVE ON METAL STAND PROVIDED BY THE MANUFACTURER.
558	INSTALL DUCTLESS SPLIT THERMOSTAT. ROUTE WIRING IN ACCORDANCE WITH MANUFACTURER'S INSTRUCTIONS.
559	REINSTALL GAS FIRED UNIT HEATER. RECONNECT TO EXISTING GAS LINE & FLUE, EXTEND AS REQUIRED.
560	ROUTE A 3/4" PVC CONDENSATE LINE, DRAIN INTO EXISTING SUMP PIT.
561	INSTALL RETURN GRILLE R-1. EXTEND AN 8" DIA. DUCT ABOVE THROUGH WALL INTO ADJACENT ROOM AS SHOWN.
562	EXISTING RETURN GRILLE TO REMAIN.




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SIGNATURE: *Karl G. Tabor*  
 DATE: 03.15.2024  
 LICENSE EXPIRES: 11-30-2024



**1** MECHANICAL - BASEMENT PLAN  
 SCALE: 1/8" = 1'-0"

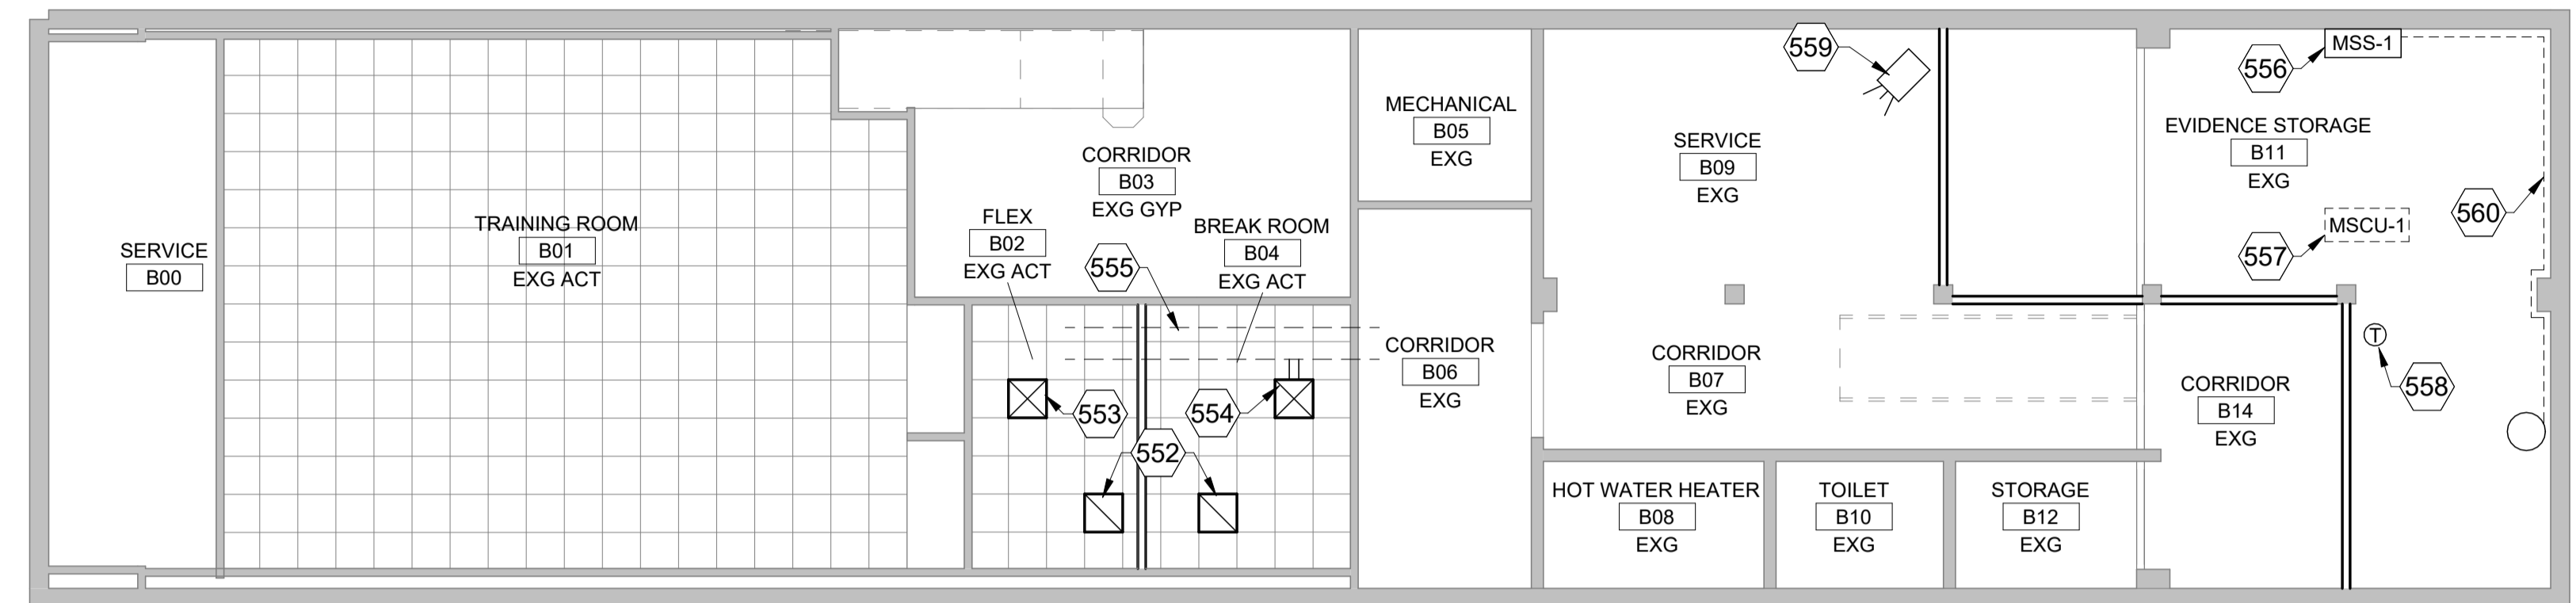

**2** MECHANICAL - FIRST FLOOR PLAN  
 SCALE: 1/8" = 1'-0"

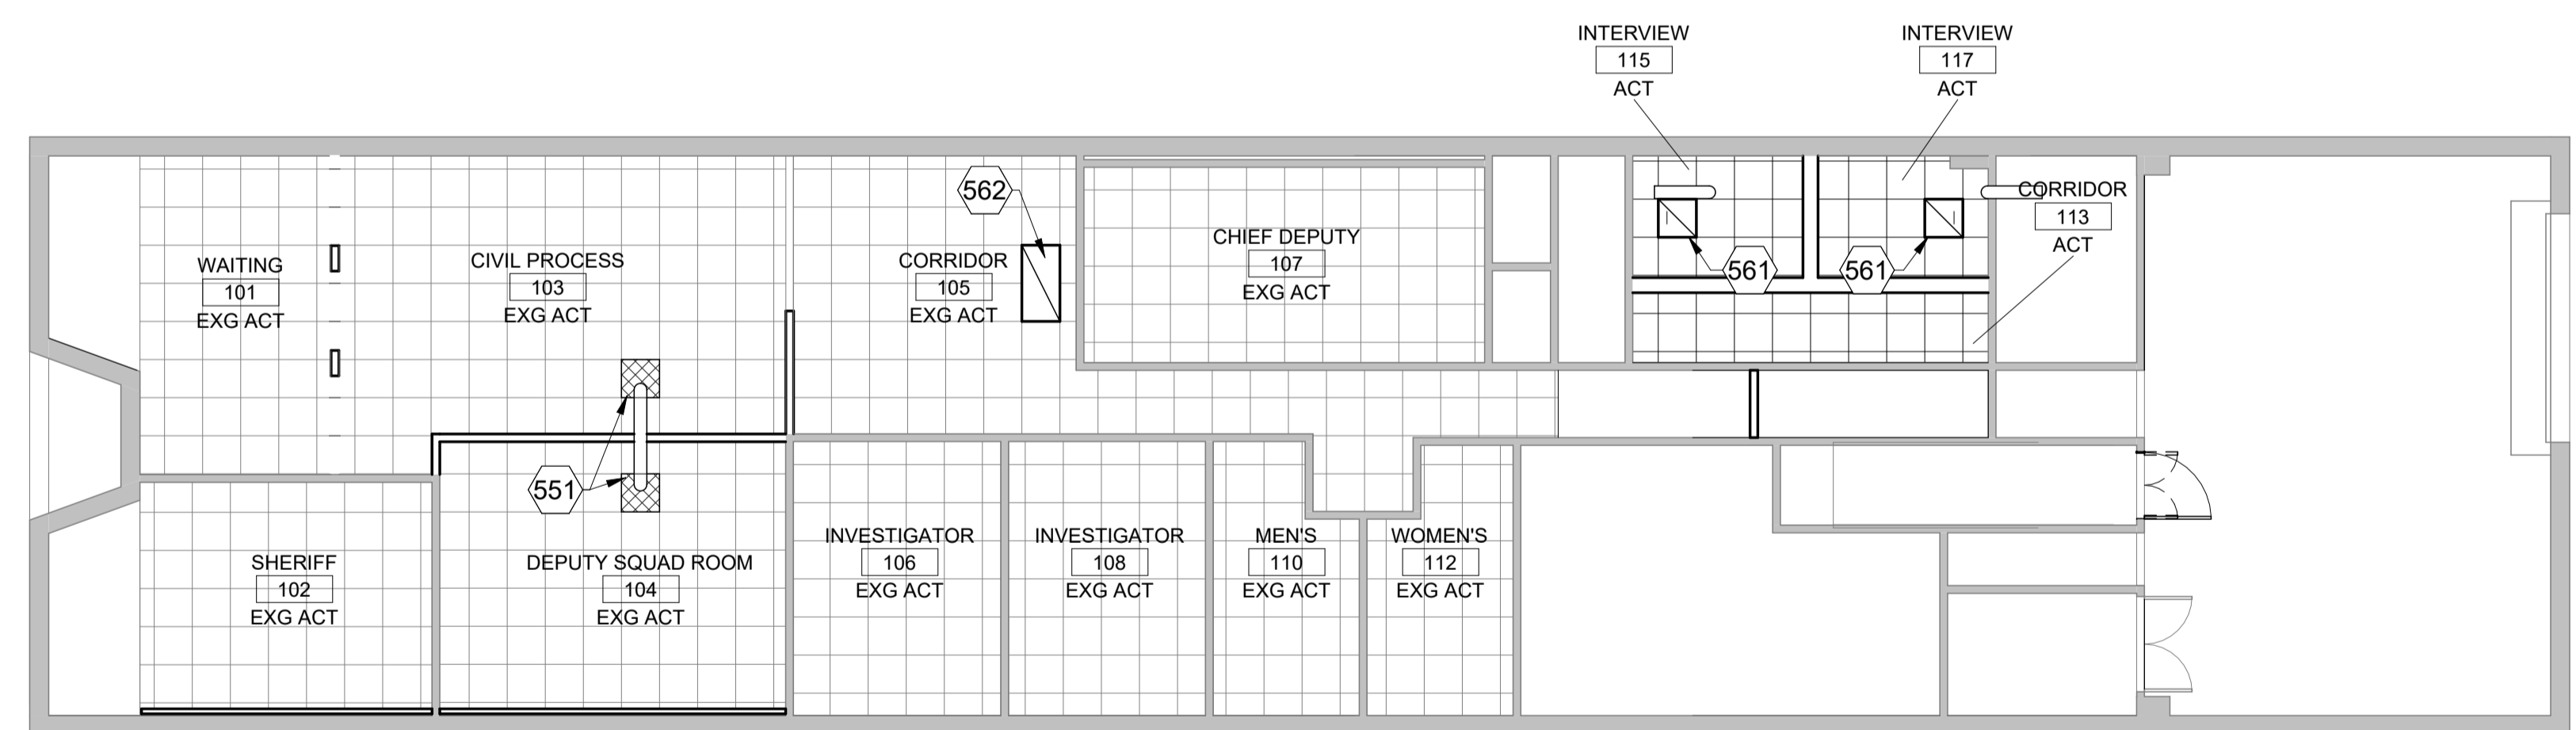KEY LEGEND

	← DETAIL NUMBER
	← SHEET NUMBER
	← HVAC - SUPPLY
	← HVAC - RETURN AIR
	← TRANSFER GRILLE

NEW OFFICE  
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MARK	DATE	DESCRIPTION

DATE: 03.15.2024  
 PROJECT NO: HR-390-1533  
 DESIGN: C/M CHECK: C/M

MEHCANICAL PLANS

**M-101**

COOLING: \_\_\_\_\_ °F AMB.

SCHEDULE OF NEW VRF HEAT PUMP UNITS								
MARK	MANUFACTURER AND MODEL NO.	SPACE SERVED	S.A. CFM	COOLING MBH	HEATING MBH	ELECTRICAL		REMARKS
						MOCP	VOLT/PH	
	TRANE PUZ-HA24NHA1 TRANE PKA-A24KA8	PER PLANS	700					


- NOTES:
1. PROVIDE WIRED WALL MOUNTED THERMOSTAT.
  2. ALL UNITS TO HAVE CONDENSATE LIFT KITS.
  3. ENTIRE SYSTEM IS R-410A.
  4. PROVIDE ALL REFRIGERANT CIRCUITS/LINESETS BETWEEN INDOOR UNITS AND OUTDOOR UNITS.
  5. PROVIDE ALL WIRING FOR CONTROLS AND COMMUNICATIONS.
  6. UNIT IS WALL MOUNTED.

SCHEDULE OF GRILLES AND DIFFUSERS										
MARK	MANUFACTURER AND MODEL NO.	TYPE	MOUNT	CFM	NECK	MODULE	DAMPER	MATERIAL	FINISH	REMARKS
	KRUEGER SHR w/ OBD	4-WAY CEILING DIFFUSER				12"x12"				1-4
	KRUEGER S80	FIXED RETURN GRILLE; 3/4" BLADES, FIXED DEFLECTION			6"x6"	12"x12"				1,4


- NOTE:
1. SEE DRAWINGS FOR LOCATION AND SIZES OF GRILLES AND DIFFUSERS.
  2. ATTACH TO DUCTWORK AS SHOWN.
  3. INCLUDE OPTIONAL BALANCING DAMPER IN NECK.
  4. MODULE SIZE IS 12"x12".

**GENERAL HVAC NOTES:**


1. PROVIDE ALL MATERIALS AND EQUIPMENT AND PERFORM ALL LABOR REQUIRED TO INSTALL COMPLETE AND OPERABLE MECHANICAL SYSTEMS AS INDICATED ON THE DRAWINGS, AS SPECIFIED AND AS REQUIRED BY CODE.
2. CONTRACT DOCUMENT DRAWINGS FOR MECHANICAL WORK ARE DIAGRAMMATIC AND ARE INTENDED TO CONVEY SCOPE AND GENERAL ARRANGEMENT ONLY.
3. INSTALL ALL MECHANICAL EQUIPMENT AND APPURTENANCES IN ACCORDANCE WITH MANUFACTURER'S RECOMMENDATIONS, CONTRACT DOCUMENTS AND APPLICABLE CODES AND REGULATIONS.
4. COORDINATE DIFFUSER, REGISTER AND GRILLE LOCATIONS WITH ARCHITECTURAL CEILING PLANS, LIGHTING AND OTHER CEILING ITEMS AND MAKE MINOR DUCT MODIFICATIONS TO SUIT.
5. LOCATE ALL MECHANICAL EQUIPMENT FOR UNOBSTRUCTED ACCESS TO UNIT ACCESS PANELS, CONTROLS, VALVING AND FACTORY RECOMMENDED CLEARANCES.
6. CONTRACTOR SHALL FLASH AND SEAL ALL ROOF PENETRATIONS AND OPENINGS CREATED BY PROJECT SCOPE PER ROOFING MANUFACTURER'S RECOMMENDATIONS. SEAL ALL PENETRATIONS THROUGH NON-CONDITIONED SPACES WITH MEDIUM DENSITY OPEN CELL SPRAY FOAM.
7. ALL DUCTWORK TO BE INSTALLED AS TIGHT TO THE UNDERSIDE OF THE STRUCTURE AS POSSIBLE TO PERMIT SPACE FOR OTHER PIPING, WIRING, ETC.
8. PROVIDE ROUND U.L. CLASS 1 FLEXIBLE DUCT WITH 1" THICK FIBERGLASS INSULATION AND BI-DIRECTIONAL REINFORCED METALLIZED VAPOR BARRIER. FLEXIBLE DUCT SHALL BE THE SAME SIZE AS AIR DISTRIBUTION DEVICE NECK DIAMETER. SECURE FLEXIBLE DUCT TO SPIN-IN AND AIR DEVICE NECK WITH CORROSION RESISTANT METAL CLAMPS AND SEAL VAPOR BARRIER WITH SMACNA APPROVED TAPE.
9. PROVIDE OPERATION AND MAINTENANCE MANUALS FOR ALL SYSTEMS TO BUILDING OWNER UPON COMPLETION.
10. WIRE TIE ALL T-BAR MOUNTED CEILING DIFFUSERS TO THE MAIN RUNNERS OF THE CEILING AND STRUCTURAL SUPPORT.

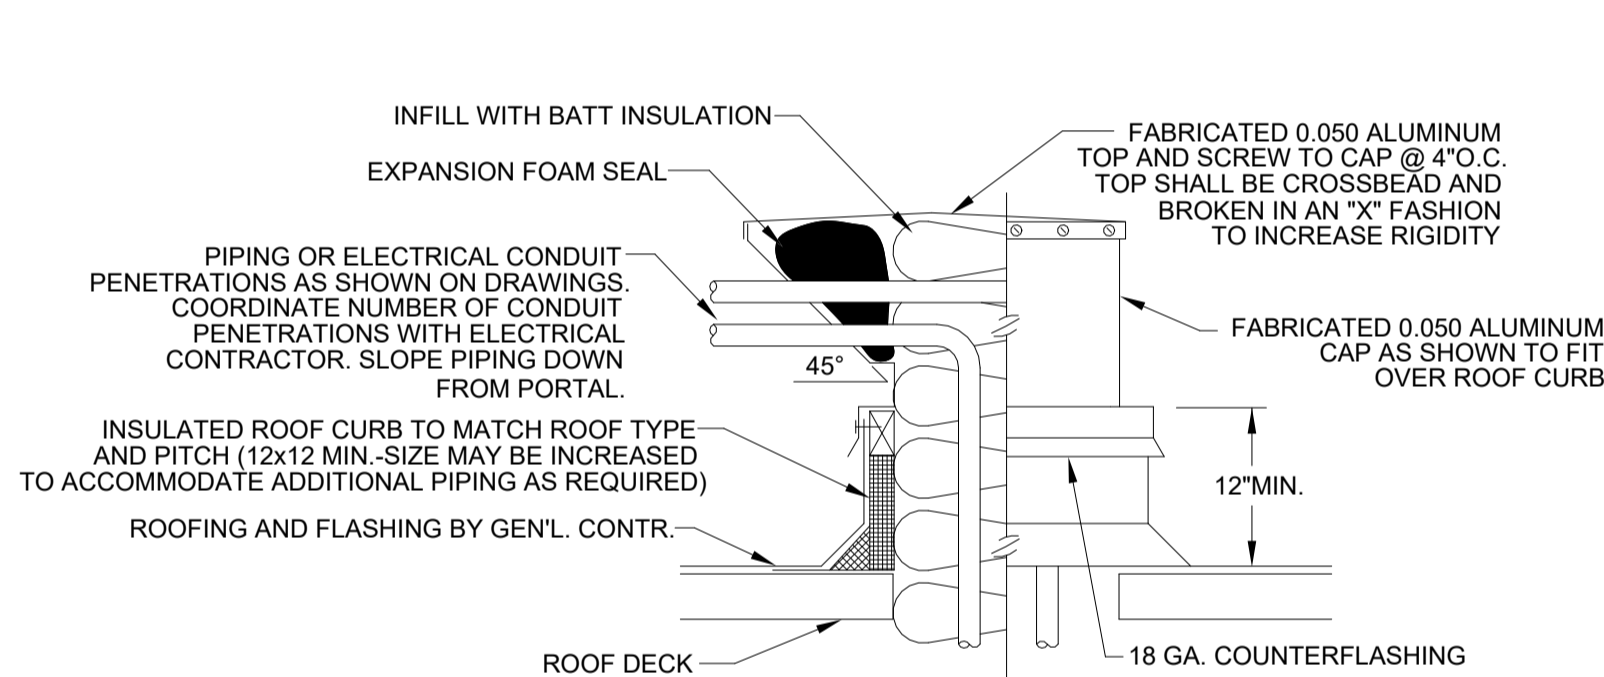

**1 FABRICATED PIPE PORTAL ROOF CURB DETAIL**  
SCALE: 12" = 1'-0"

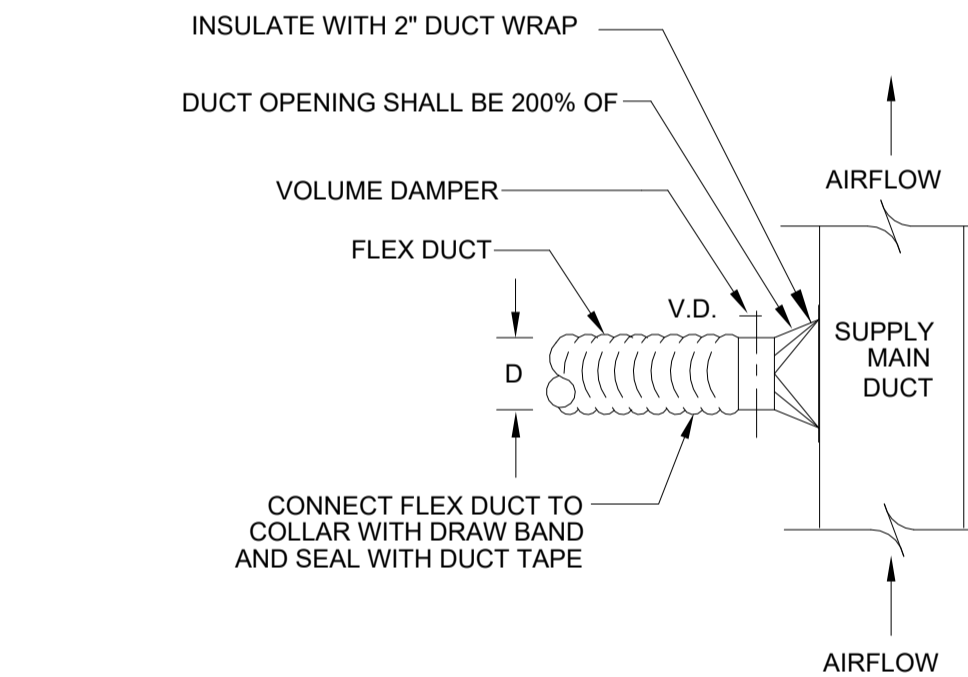

**3 FLEX DUCT CONNECTION DETAILS**  
SCALE: 12" = 1'-0"

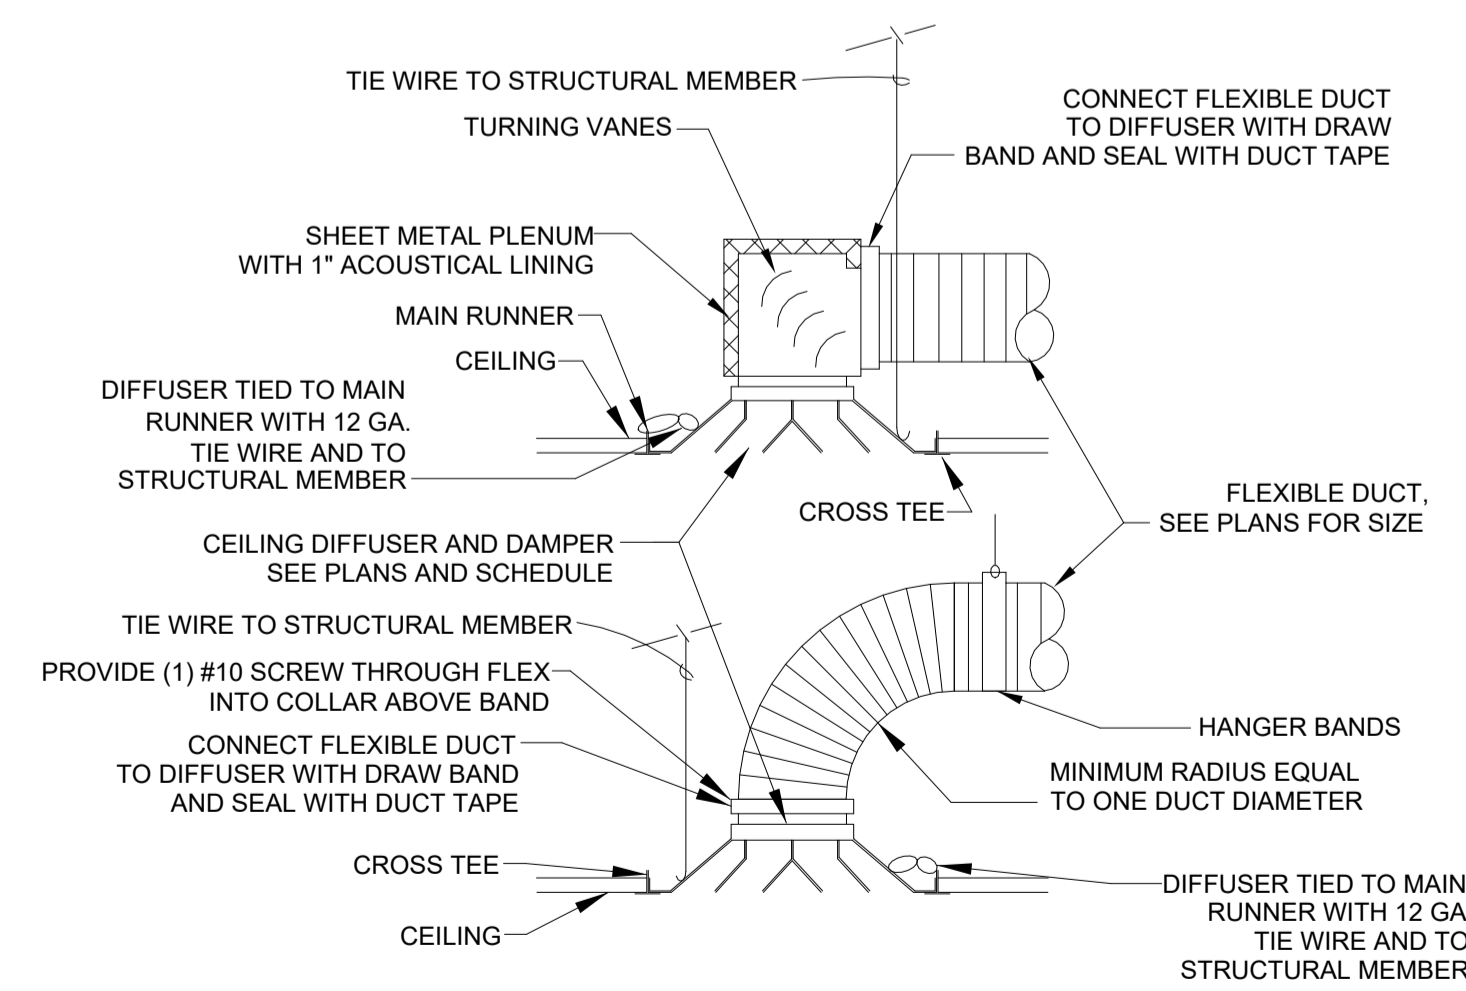

**2 DIFFUSER FLEX CONNECTION DETAIL A.C.T.**  
SCALE: 12" = 1'-0"

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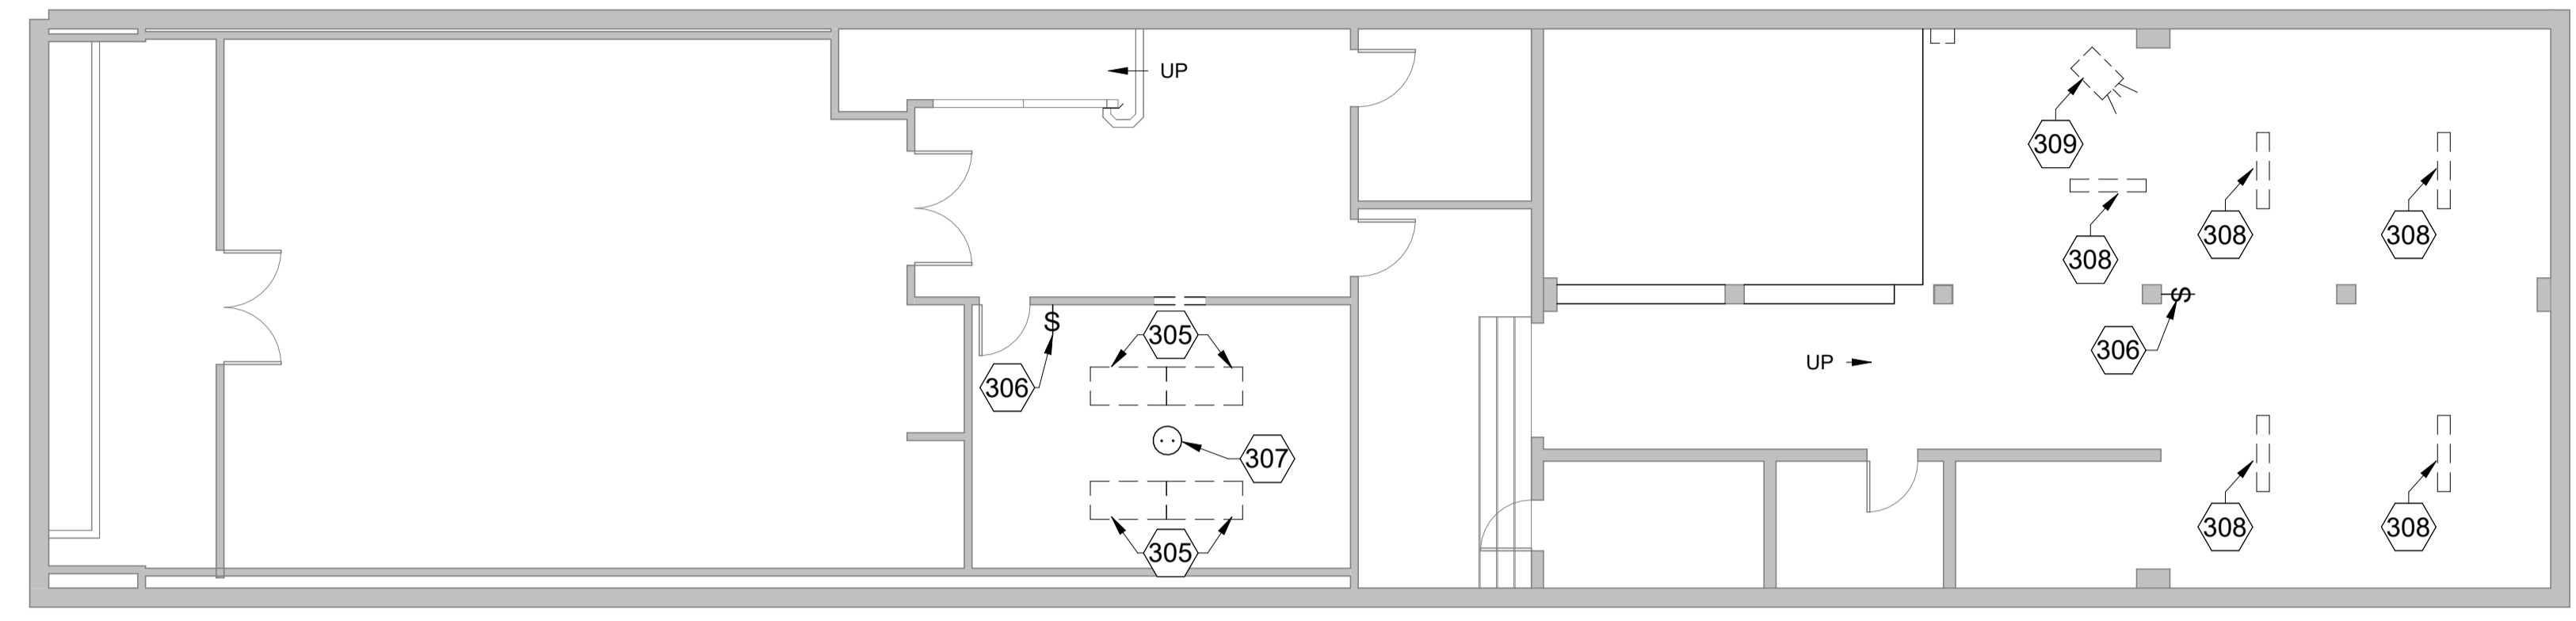
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MARK	DATE	DESCRIPTION

MECHANICAL SCHEDULES AND DETAILS


**M-601**



**1**  
ED-101  
**BASEMENT DEMOLITION PLAN**

0' 4' 8' 16' 32'

SCALE: 1/8" = 1'-0"

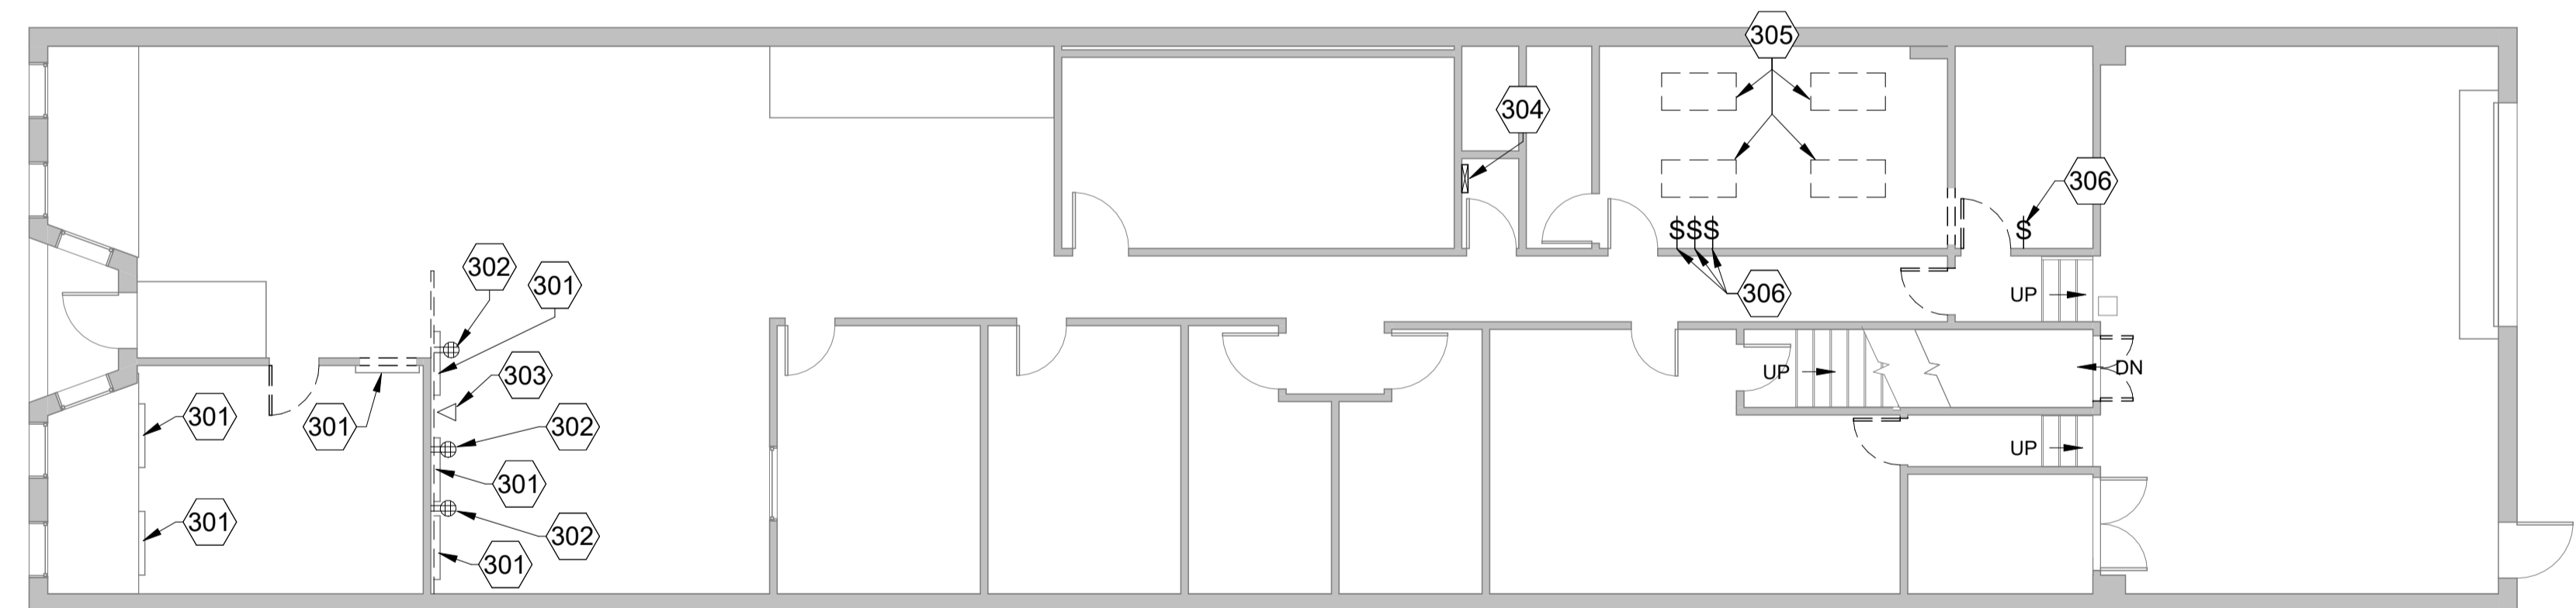

**2**  
ED-101  
**FIRST FLOOR DEMOLITION PLAN**

0' 4' 8' 16' 32'

SCALE: 1/8" = 1'-0"

KEYNOTE LEGEND	
MARK	KEYNOTE
301	REMOVE EXISTING ELECTRIC BASEBOARD HEATER AND RELATED ELECTRIC CIRCUIT AND WIRING.
302	REMOVE EXISTING QUADPLEX RECEPTACLE AND RELATED ELECTRIC CIRCUIT AND WIRING.
303	REMOVE EXISTING DATA JACKS, AND ALL RELATED DATA WIRING AND ACCESSORIES.
304	EXISTING SQUARE D ELECTRICAL PANEL SHALL REMAIN.
305	REMOVE AND SALVAGE EXISTING LIGHT FIXTURE FOR REINSTALLATION AS INDICATED.
306	REMOVE EXISTING LIGHT SWITCH AND RELATED WIRING.
307	REMOVE EXISTING OCCUPANCY SENSOR AND RELATED WIRING.
308	REMOVE EXISTING LIGHT FIXTURE AND RELATED WIRING.
309	DISCONNECT ELECTRICAL CIRCUIT FOR EXISTING UNIT HEATER AND PREPARE FOR RECONNECTION AS INDICATED.

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STATE OF ILLINOIS  
KARL G. TABOR  
001-015084  
LICENSED ARCHITECT

SIGNATURE  
03.15.2024  
DATE  
11-30-2024  
LICENSE EXPIRES

KEY LEGEND	
\$	← SWITCH
⊕	← DUPLEX RECEPTACLE
⊕	← QUADPLEX RECEPTACLE
⊙	← OCCUPANCY SENSOR
△	← DATA PORT


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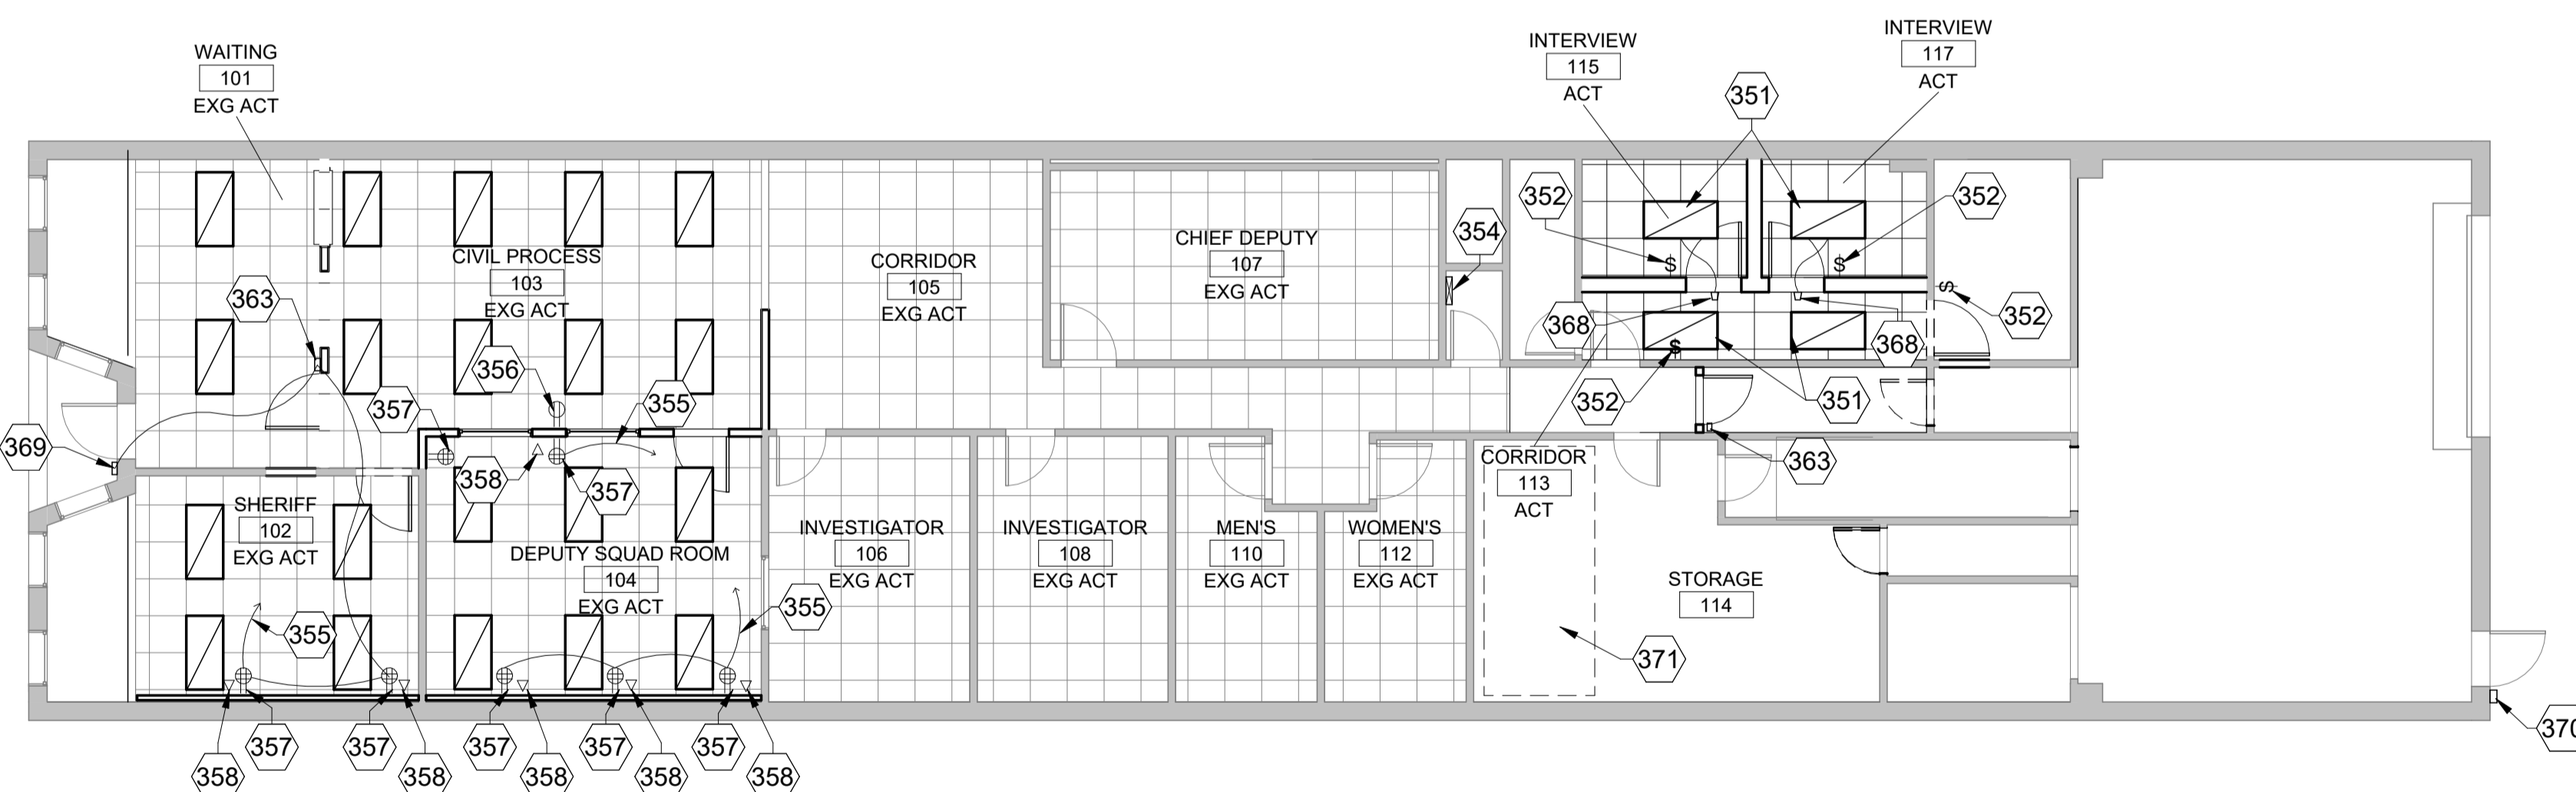
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PROJECT NO: HR-390-1533  
DESIGN: DRAWN: CHECK:  
CIM

ELECTRICAL  
DEMOLITION PLANS

**ED-101**



**1 ELECTRICAL - BASEMENT PLAN**  
 N  
 0' 4' 8' 16' 32'  
 SCALE: 1/8" = 1'-0"

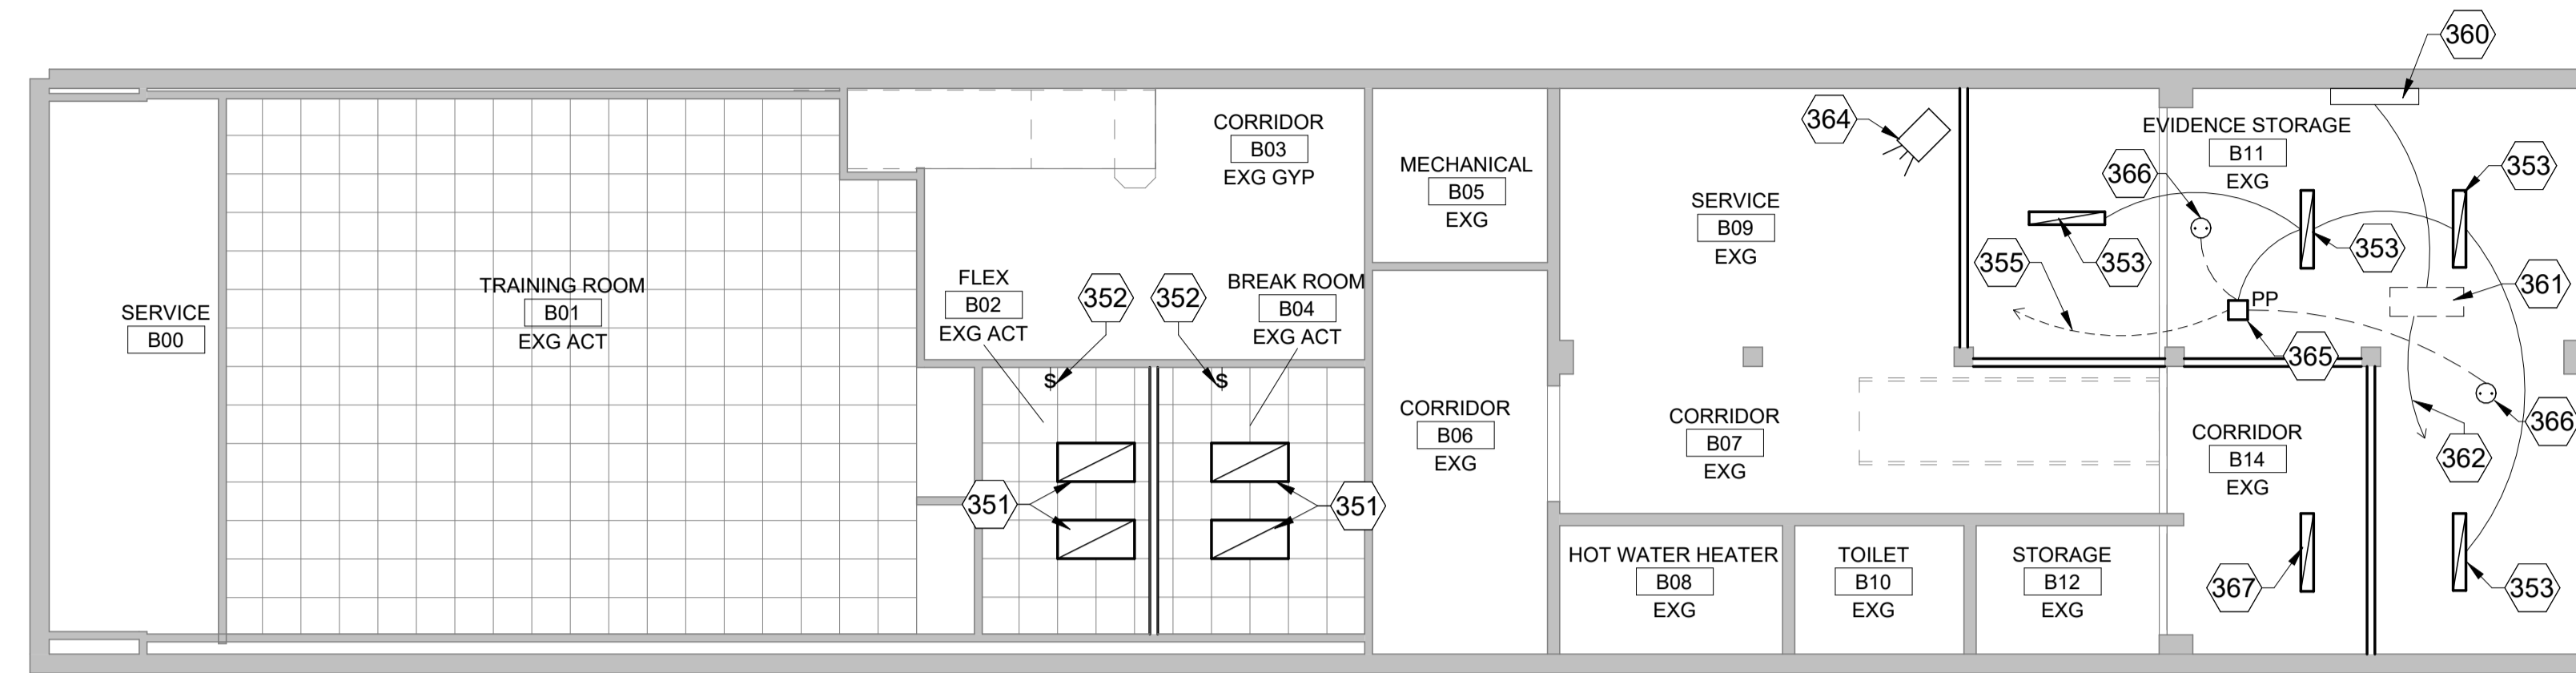

**2 ELECTRICAL - FIRST FLOOR PLAN**  
 N  
 0' 4' 8' 16' 32'  
 SCALE: 1/8" = 1'-0"

**KEYNOTE LEGEND**

MARK	KEYNOTE
351	REINSTALL SALVAGED LIGHT FIXTURE. RECONNECT TO EXISTING WIRING IN THIS SPACE AS REQUIRED.
352	INSTALL OCCUPANCY SENSOR SWITCH, STEINEL MODEL DT WLS 1. ROUTE WIRING FROM SENSOR SWITCH TO THE LIGHT FIXTURES IN THIS SPACE.
353	INSTALL SURFACE MOUNTED LIGHT FIXTURE, DAYBRITE MODEL FSS440L840-UNV-DIM.
354	EXISTING SQUARE D ELECTRICAL PANEL SHALL REMAIN.
355	ROUTE #12 AWG MC CABLE TO THE EXISTING ELECTRICAL PANEL LOCATED AS SHOWN. INSTALL A 20A/1P CIRCUIT BREAKER IN PANEL FOR THIS CIRCUIT.
356	INSTALL DUPLEX RECEPTACLE IN NEW WALL.
357	INSTALL QUADPLEX RECEPTACLE IN NEW WALL.
358	INSTALL A SINGLE GANG BACKBOX WITH 3/4" EMT CONDUIT STUBBED TO ABOVE CEILING FOR FUTURE DATA CABLING.
360	PROVIDE ELECTRICAL CONNECTIONS FOR WALL CASSETTE. ROUTE WIRING TO OUTDOOR UNIT AS REQUIRED.
361	PROVIDE NEMA 3R DISCONNECT SWITCH AND ELECTRICAL CONNECTIONS FOR DUCTLESS SPLIT OUTDOOR UNIT ON ROOF.
362	ROUTE #10 AWG MC CABLE TO THE EXISTING ELECTRICAL PANEL LOCATED AS SHOWN. INSTALL A 30A/2P CIRCUIT BREAKER IN PANEL FOR THIS CIRCUIT.
363	PROVIDE SINGLE GANG BACKBOX WITH 3/4" EMT CONDUIT STUBBED TO ABOVE CEILING FOR ACCESS CONTROL SYSTEM EQUIPMENT, BY OWNER. PROVIDE 120V ELECTRICAL CONNECTIONS FOR ELECTRIC LOCK. CONNECT TO THE EXISTING RECEPTACLE CIRCUIT IN THIS SPACE.
364	RECONNECT EXISTING ELECTRICAL CIRCUIT TO RELOCATED UNIT HEATER AS REQUIRED.
365	INSTALL OCCUPANCY SENSOR POWER PACK, STEINEL MODEL TR-100.
366	INSTALL OCCUPANCY SENSOR, STEINEL MODEL DT-1UATTRO-COM1-24.
367	INSTALL SURFACE MOUNTED LIGHT FIXTURE, DAYBRITE MODEL FSS440L840-UNV-DIM. CONNECT WIRING TO THE EXISTING SWITCHING CIRCUIT IN THE BASEMENT.
368	INSTALL SURFACE MOUNTED 120V DOME LIGHT FIXTURE CENTERED ABOVE DOOR, EDWARDS SIGNALING MODEL CFA-7641-1N5. ROUTE WIRING TO DOME LIGHT FROM OCCUPANCY SWITCH CONTROLLED LIGHT FIXTURE.
369	PROVIDE EXTERIOR SINGLE GANG BACKBOX WITH 3/4" EMT CONDUIT STUBBED TO ABOVE CEILING FOR ACCESS CONTROL SYSTEM EQUIPMENT, BY OWNER. PROVIDE 120V ELECTRICAL CONNECTIONS FOR ELECTRIC LOCK. CONNECT TO THE EXISTING RECEPTACLE CIRCUIT IN THIS SPACE.
370	PROVIDE EXTERIOR SINGLE GANG BACKBOX WITH 3/4" EMT CONDUIT STUBBED TO INTERIOR OF BUILDING ABOVE CEILING FOR ACCESS CONTROL SYSTEM EQUIPMENT, BY OWNER. PROVIDE 120V DIRECT CONNECT.
371	AT ATTIC I.T. ROOM ABOVE STORAGE 114, PROVIDE QUADPLEX RECEPTACLE FOR DDOR OPERATORS BY OWNER'S VENDOR.



**HURST-ROSCHKE, INC.**  
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 NASHVILLE, TN  
 SPRINGFIELD, IL



SIGNATURE: *Karl G. Tabor*  
 DATE: 03.15.2024  
 LICENSE EXPIRES: 11-30-2024

**NEW OFFICE**  
**CHRISTIAN COUNTY SHERIFF'S DEPARTMENT**  
 214 WEST MARKET STREET  
 TAYLORVILLE, ILLINOIS 62568  
**ISSUED FOR BID**

MARK	DATE	DESCRIPTION

DATE: 03.15.2024  
 PROJECT NO: HR-390-1533  
 DESIGN:    DRAWN:    CHECK: C/M

**KEY LEGEND**

\$	← SWITCH
⊕	← DUPLEX RECEPTACLE
⊕	← QUADPLEX RECEPTACLE
⊙	← OCCUPANCY SENSOR
△	← DATA PORT

**ELECTRICAL PLANS**

**E-101**